

Area Schedule (GEA) - Option 7 (Indicative Only)			
Area			
Name	Metric	Imperial	
Unit 1			
GF GEA	3,927.10 m ²	42,271 ft ²	
FF GEA	411.06 m ²	4,425 ft ²	
	4,338.16 m ²	46,696 ft ²	
Unit 2			
GF GEA	6,667.03 m ²	71,763 ft ²	
FF GEA	731.08 m ²	7,869 ft ²	
	7,398.11 m ²	79,633 ft ²	
TOTAL:: 4	11,736.27 m²	126,328 ft²	

Parking Schedule - Option7			Site Ar	ea
Description	Count	Mark	Name	
nit 1				
andard car parking bay	48			
sabled parking bay	3	Unit 1	Site Area	
ectric Charge Car Parking Bay	3	Unit 2	Site Area	
	54	Offic 2	One Area	
nit 2				
andard car parking bay	46			
sabled parking bay	4			
ectric Charge Car Parking Bay	3			
	53			
OTAL: 107	107			



					hawWBHA
0m 10m	1 20m	<u>30m</u> 40m	N	This drawing is © C4 Projects and is not to be copied, reproduced or re- distributed either in whole or in part without the prior written permission of the originator.	W_Steven.SI
VISUAL SCAL	E 1:500 @	A1	\bigcirc	The originator shall have no responsibility for any liability, loss, cost, damage or expense arising from or relating to any use of this document other than for its intended purpose on this project.	9601_Site NE
				This drawing shall be read in conjunction with all other relevant drawings, specifications and associated documentation. Any discrepencies, errors or omissions are to be reported to the originator before proceeding with work.	9-A-6M3-A-6
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				SOFTWARE INTEROPERABILITY C4 Projects prepared this drawing using Autodesk <u>REVIT</u> Architecture.	Jocuments
				C4 Projects does not accept liability for any loss or degradation of any information held in the drawing resulting from the translation from the original file format to any other file format or from the recipients reading of it in any other programme.	C:\UsersSteven.Shaw\Documents21012.C4P-AV-XX:M3-A-9601_Ste NEW_Steven.ShawWBHAF
				Hazard Identification	
				ref hazard date	e
		Application Boundary Proposed Building Proposed Office	А. В.	Unless noted otherwise, all known hazards have been identified on this drawing. Known risks of significant and project specific nature have also been captured on the 'Designers Risk Assessment' (DRA) Schedule.	
		Proposed Office	C.	Should unexpected risks arise, EA/CA to be notified immediately.	
		Existing Building	D.	The principal contractor is to execute and complete the works under the duties as required of the current	
		Soft Landscaping		CDM regulations.	
		5m Landscape Buffer	E.	NO additional risks are expected as a result or consequence of the proposed works.	
		Concrete Yard	F.	Access Strategy proposals for `Cleaning & Maintenance' are defined under separate dedicated document(s).	
		Tarmac Road	G.	Refer to consultant Engineer's (Geotechnical, Civil, Structural, Mechanical and Electrical) drawings and	
		Path / Paving		specifications for any risks associated with those work package elements (including any demolition and / or enabling works).	
	\times	Permeable Paving Slabs			
		Level Access Loading Door			
		Dock Leveller Doors			
		Main Entrance			
		Sub Station			
		Bin Store Provision			
		Bicycle Provision			

Drawing Status

— — Paladin Fence & Gate

C02 Site update and GEAs indicated SS 14.10.22 SS 09.09.22 C01 Full Construction Issue P14 Construction Issue with Site SS 09.09.22 amendments P13 Unit 1 yard and paths amended per SS 08.08.22 retaining structure SS 24.06.22 P12 General update. Contract Issue. P11 PLANNING ISSUE. Notes amended as A.AL 01.06.22 SS required by Planning. P10 Kerbline revised within site demise. SS 24.05.22 Footpaths update and unit 2 offices extended. P9 Levels, Additional Tracking and Site A.AL 18.05.22 SS update A.AL 28.04.22 SS P8 Site updated. P7 Minor site feature amendment for HGV SS 06.04.22 DC tracking P6 Units repositioned. Unit 1 office block SS 22.03.22 NR and car park amended BE 24.01.22 DC P5 Tender Issue P4 Update Issue BC 14.12.21 DC BC 13.12.21 DC P3 Scale Note Amended P2 GIA schedule Added BE 06.12.21 DC BE 19.11.21 DC P1 Planning Issue

Rev Revision Details

 Quayside,

 Wilderspool Business Park,

 Stockton Heath,

 WA4 6HL

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 www.c4projects.co.uk

Drawn Date Checked

Project Management • Architecture • Building Surveying • Cost Consultancy


Client

GP Developments (Newbury) Limited

Project Greenham Business Park Newbury

Drawing Title Site Plan as Proposed

Drawn by	BE	Create	d 1	9.11.21
C4 Job no.	21-012	Scale	As indicated	@ A1
Drg no. 21012-C4P-AV-ZZ-DR-A-0500		Rev C02		

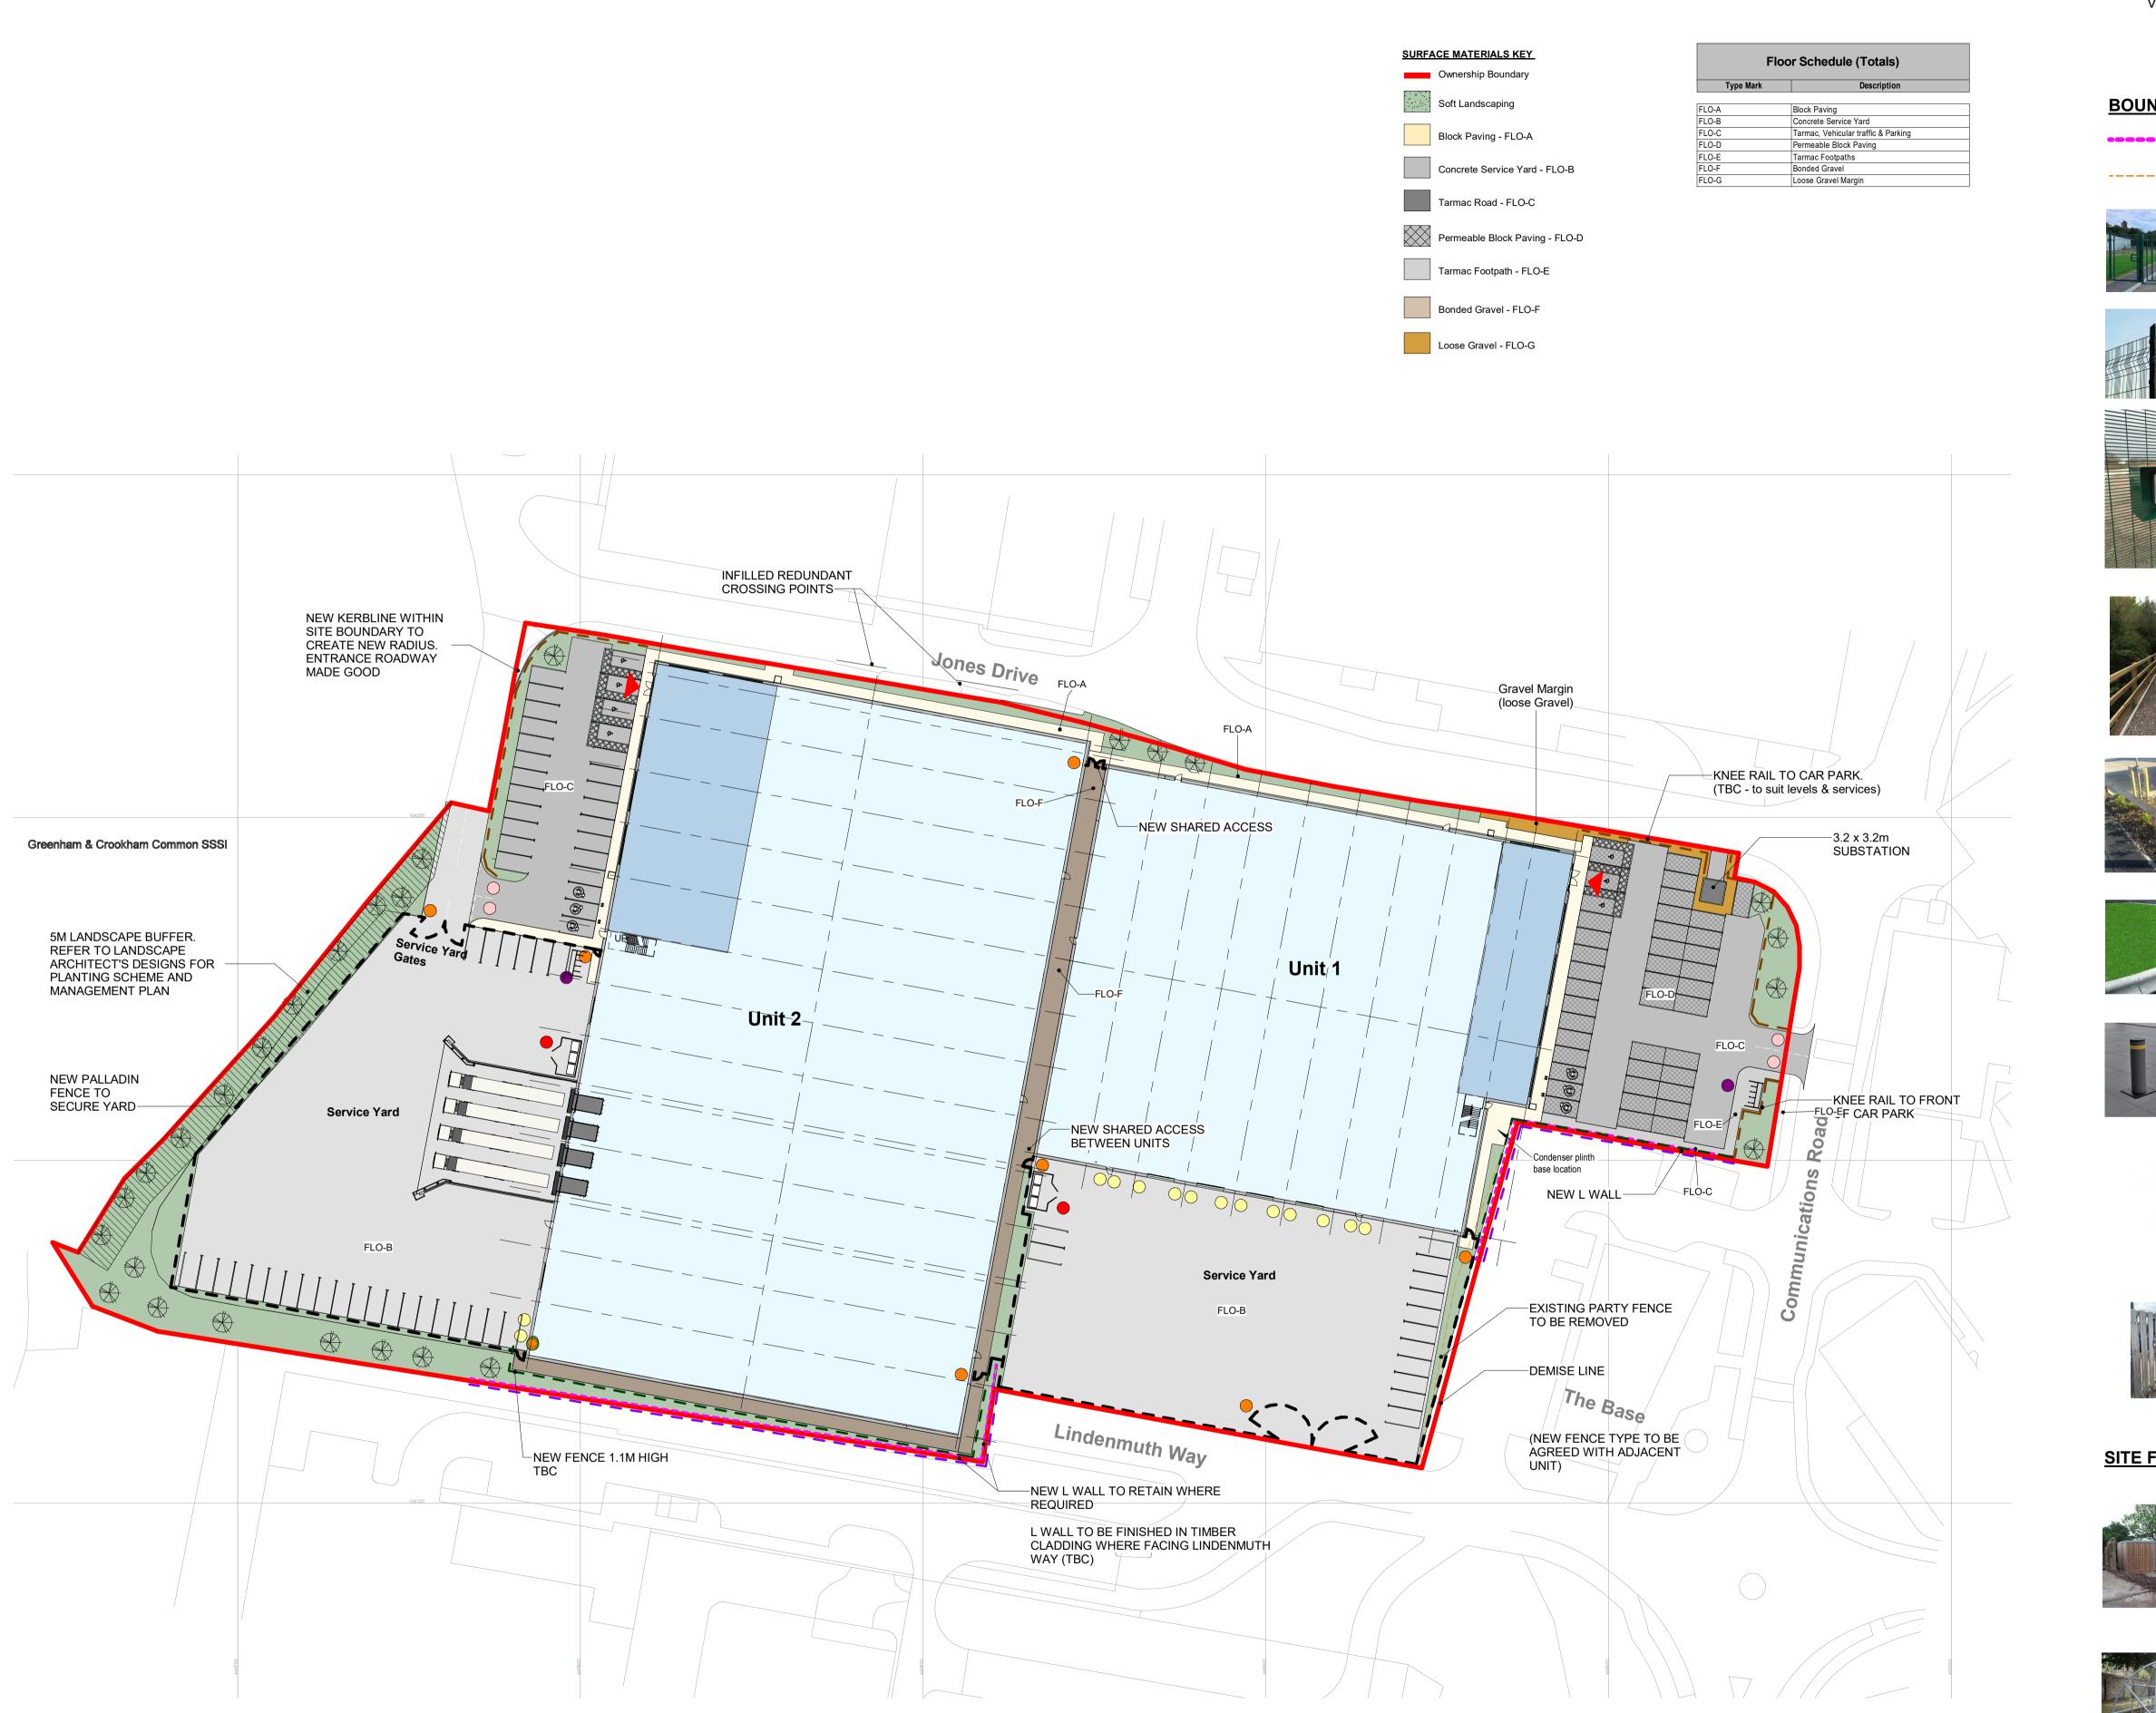

	CALE 1:500 @ A1 🛛 🗸 🗸 🗸	CONSTRUCTION
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NDARY 1	TREATMENT KEY	omissions are to be reported to the originator before proceeding with work. DISCLAIMER
	Retaining Structure	When this drawing is issued in CAD, it is an uncontrolled version issued for information only, to enable the recipient to prepare their own documents/ drawings for which they are solely responsible.
	L-WALL Line of Existing Fencing to be relocated	SOFTWARE INTEROPERABILITY C4 Projects prepared this drawing using Autodesk <u>REVIT</u> Architecture. C4 Projects does not accept liability for any loss or degradation of any
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10		
	Gates	Hazard Identification
		ref hazard definition date
	Paladin Fencing with gates as indicated:	
	Mesh panel - mesh size 200 x 50/20mm - 5mm horizontal wire, 4mm vertical wire.	DESIGN HAZARD IDENTIFICATI
	Post size 60 x 60mm SHS. Plastic cap 60 x 60mm. M8 x 30 stainless steel security screw.	 Unless noted otherwise, all known hazards have been identified on this drawing.
	Triangular folds - 2, 3, 4 or 5 per panel (depending on height).	 Known risks of significant and project specific nature have also been captured on the 'Designers Risk
	Durable Plastic Clip, or can be substituted for a metal clip. Holes for additional inserts top and bottom	Assessment' (DRA) Schedule. C. Should unexpected risks arise, EA/CA to be notified
	for stepping purposes. Height is to be ~2.4m.	immediately.
PUSH	All pedestrian gates to have push pad for emergency escape to facilitate rapid exit	D. The principal contractor is to execute and complete the works under the duties as required of the current CDM regulations.
	through gates. A security shroud should also be fitted to prevent access to the push pad from the outside.	 NO additional risks are expected as a result or consequence of the proposed works.
		F. Access Strategy proposals for `Cleaning &
		Maintenance' are defined under separate dedicated document(s).
		G. Refer to consultant Engineer's (Geotechnical, Civil, Structural, Mechanical and Electrical) drawings and specifications for any risks associated with those work
		package elements (including any demolition and / or enabling works).
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	Post & Rail Fence	
	_	
The start	1. Contraction of the second sec	
a produced		
	Timber Knee Rail	
	<u>Timber Knee Rail</u>	
	Timber Knee Rail	
	Trief Kerb	
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	Car Park Entrance Protection Telescopic bollards to car park	C05Minor bdy treatments/finishes amendsSS02.02.23C04Sub-station InformationSS05.12.22C03Boundary Treatments updatedGN23.11.22SS
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base and to be fixed to service yard slab. Height: 2000mm, with gap at the bottom of 100mm

Size: (to meet BREEAM requirements) minimum


10.0m2 for 4No. Eurobins.

Cycle Shelters

Project Greenham Business Park Newbury

Drawing Title Boundary Treatment / Hard Landscaping Plan

Drg no. 21012-C4	P-AV-ZZ-D	R-A-0	501	Rev C05
C4 Job no.	21-012	Scale	As indicated	@ A1
Drawn by	BE	Create	d 1	9.11.21

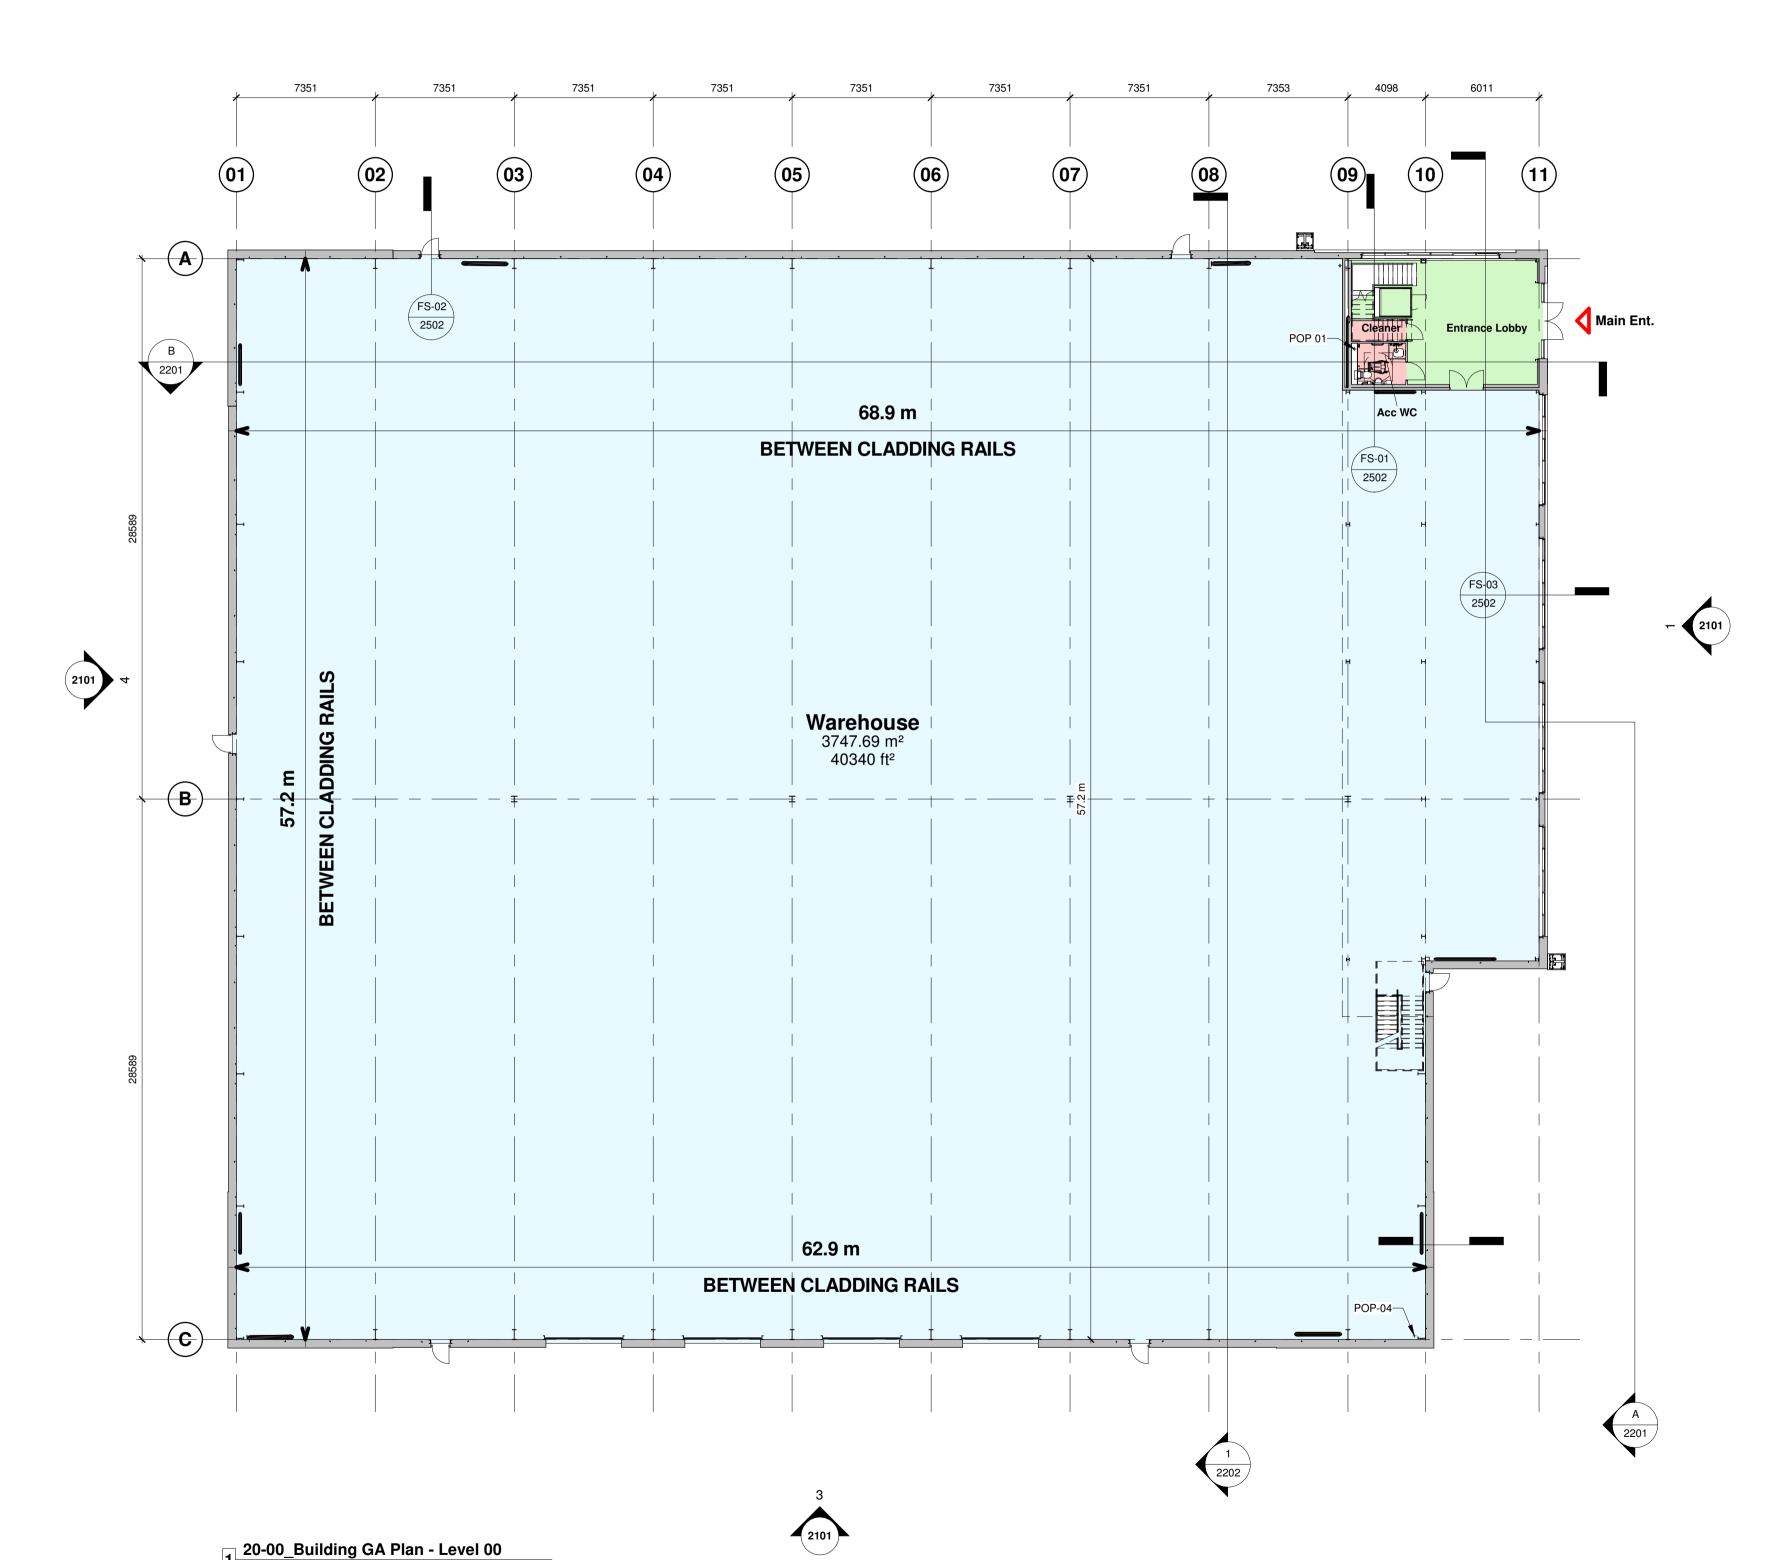

1 20-00_Building GA Plan - Level 00





N	0m	4m	8m	n 16m	Drawing Status	
					CONSTRUCTION	N
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					This drawing shall be read in conjunction with all other re specifications and associated documentation. Any discre omissions are to be reported to the originator before proc	epencies, errors or
	Area Sch	edule (GIA)			DISCLAIMER	
					When this drawing is issued in CAD, it is an uncontrolled information only, to enable the recipient to prepare their of	
		A	Area		drawings for which they are solely responsible.	
Number	Name	Metric	Imperial		SOFTWARE INTEROPERABILITY C4 Projects prepared this drawing using Autodesk REVI	TArchitocturo
					C4 Projects prepared this drawing using Autodesk <u>REVT</u>	
		0.000.102	41 100 #2			
nit 1	GF GIA	3,820.13 m ²	41,120 ft ²		C4 Projects does not accept liability for any loss or degra	
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Gross Internal Area (GIA) Requirements

Development proposals comprise of the following GIA accommodation. Check measurements will be recorded as listed below and as depicted on the floor plans.

Warehouse Area: Dimensions taken to inside face of the sheeting rails.

Office: Dimensions taken to internal finished faces of perimeter wall linings.

2. For contractual requirements on building areas and schedule of minimum GIA'S refer to the "Employers requirements" document.

GIA dimensions on this drawing are target value only.
 Employers requirements to achieve minimum GIA accommodation shall take precedence.

The contractor's designers are to provide 'measurement Plans' for employer approval. These shall confirm how GIA requirements will be achieved.

5. ALL dimensions indicated are subject to change during detailed design of structural steel frame and building envelope systems. Full coordination required with all relevant sub- contractors / specialists.

C01	Full Construction Issue	AW	13.09.22	SS
P12	Construction Issue	SS	01.08.22	
P11	Fabrication model co-ordination update	SS	26.07.22	
P10	General update. Contract Issue.	A.AL	28.06.22	SS
P9	PLANNING ISSUE. Notes amended as required by Planning.	A.AL	01.06.22	SS
P8	Minor structural co-ordination	SS	24.05.22	
P7	Layout & Areas updated.	A.AL	19.05.22	SS
P6	SE Co-ordination and Specifications Update.	A.AL	27.04.22	SS
P5	Unit Size Revised.	A.AL	21.04.22	SS
P4	Tender Issue	BE	24.01.22	DC
P3	Scale Note Amended	BC	13.12.21	DC
P2	GIA updated	BE	06.12.21	DC
P1	First Issue of Drawing	BE	16.11.21	DC
Rev	Revision Details	Drawn	Date	Checked

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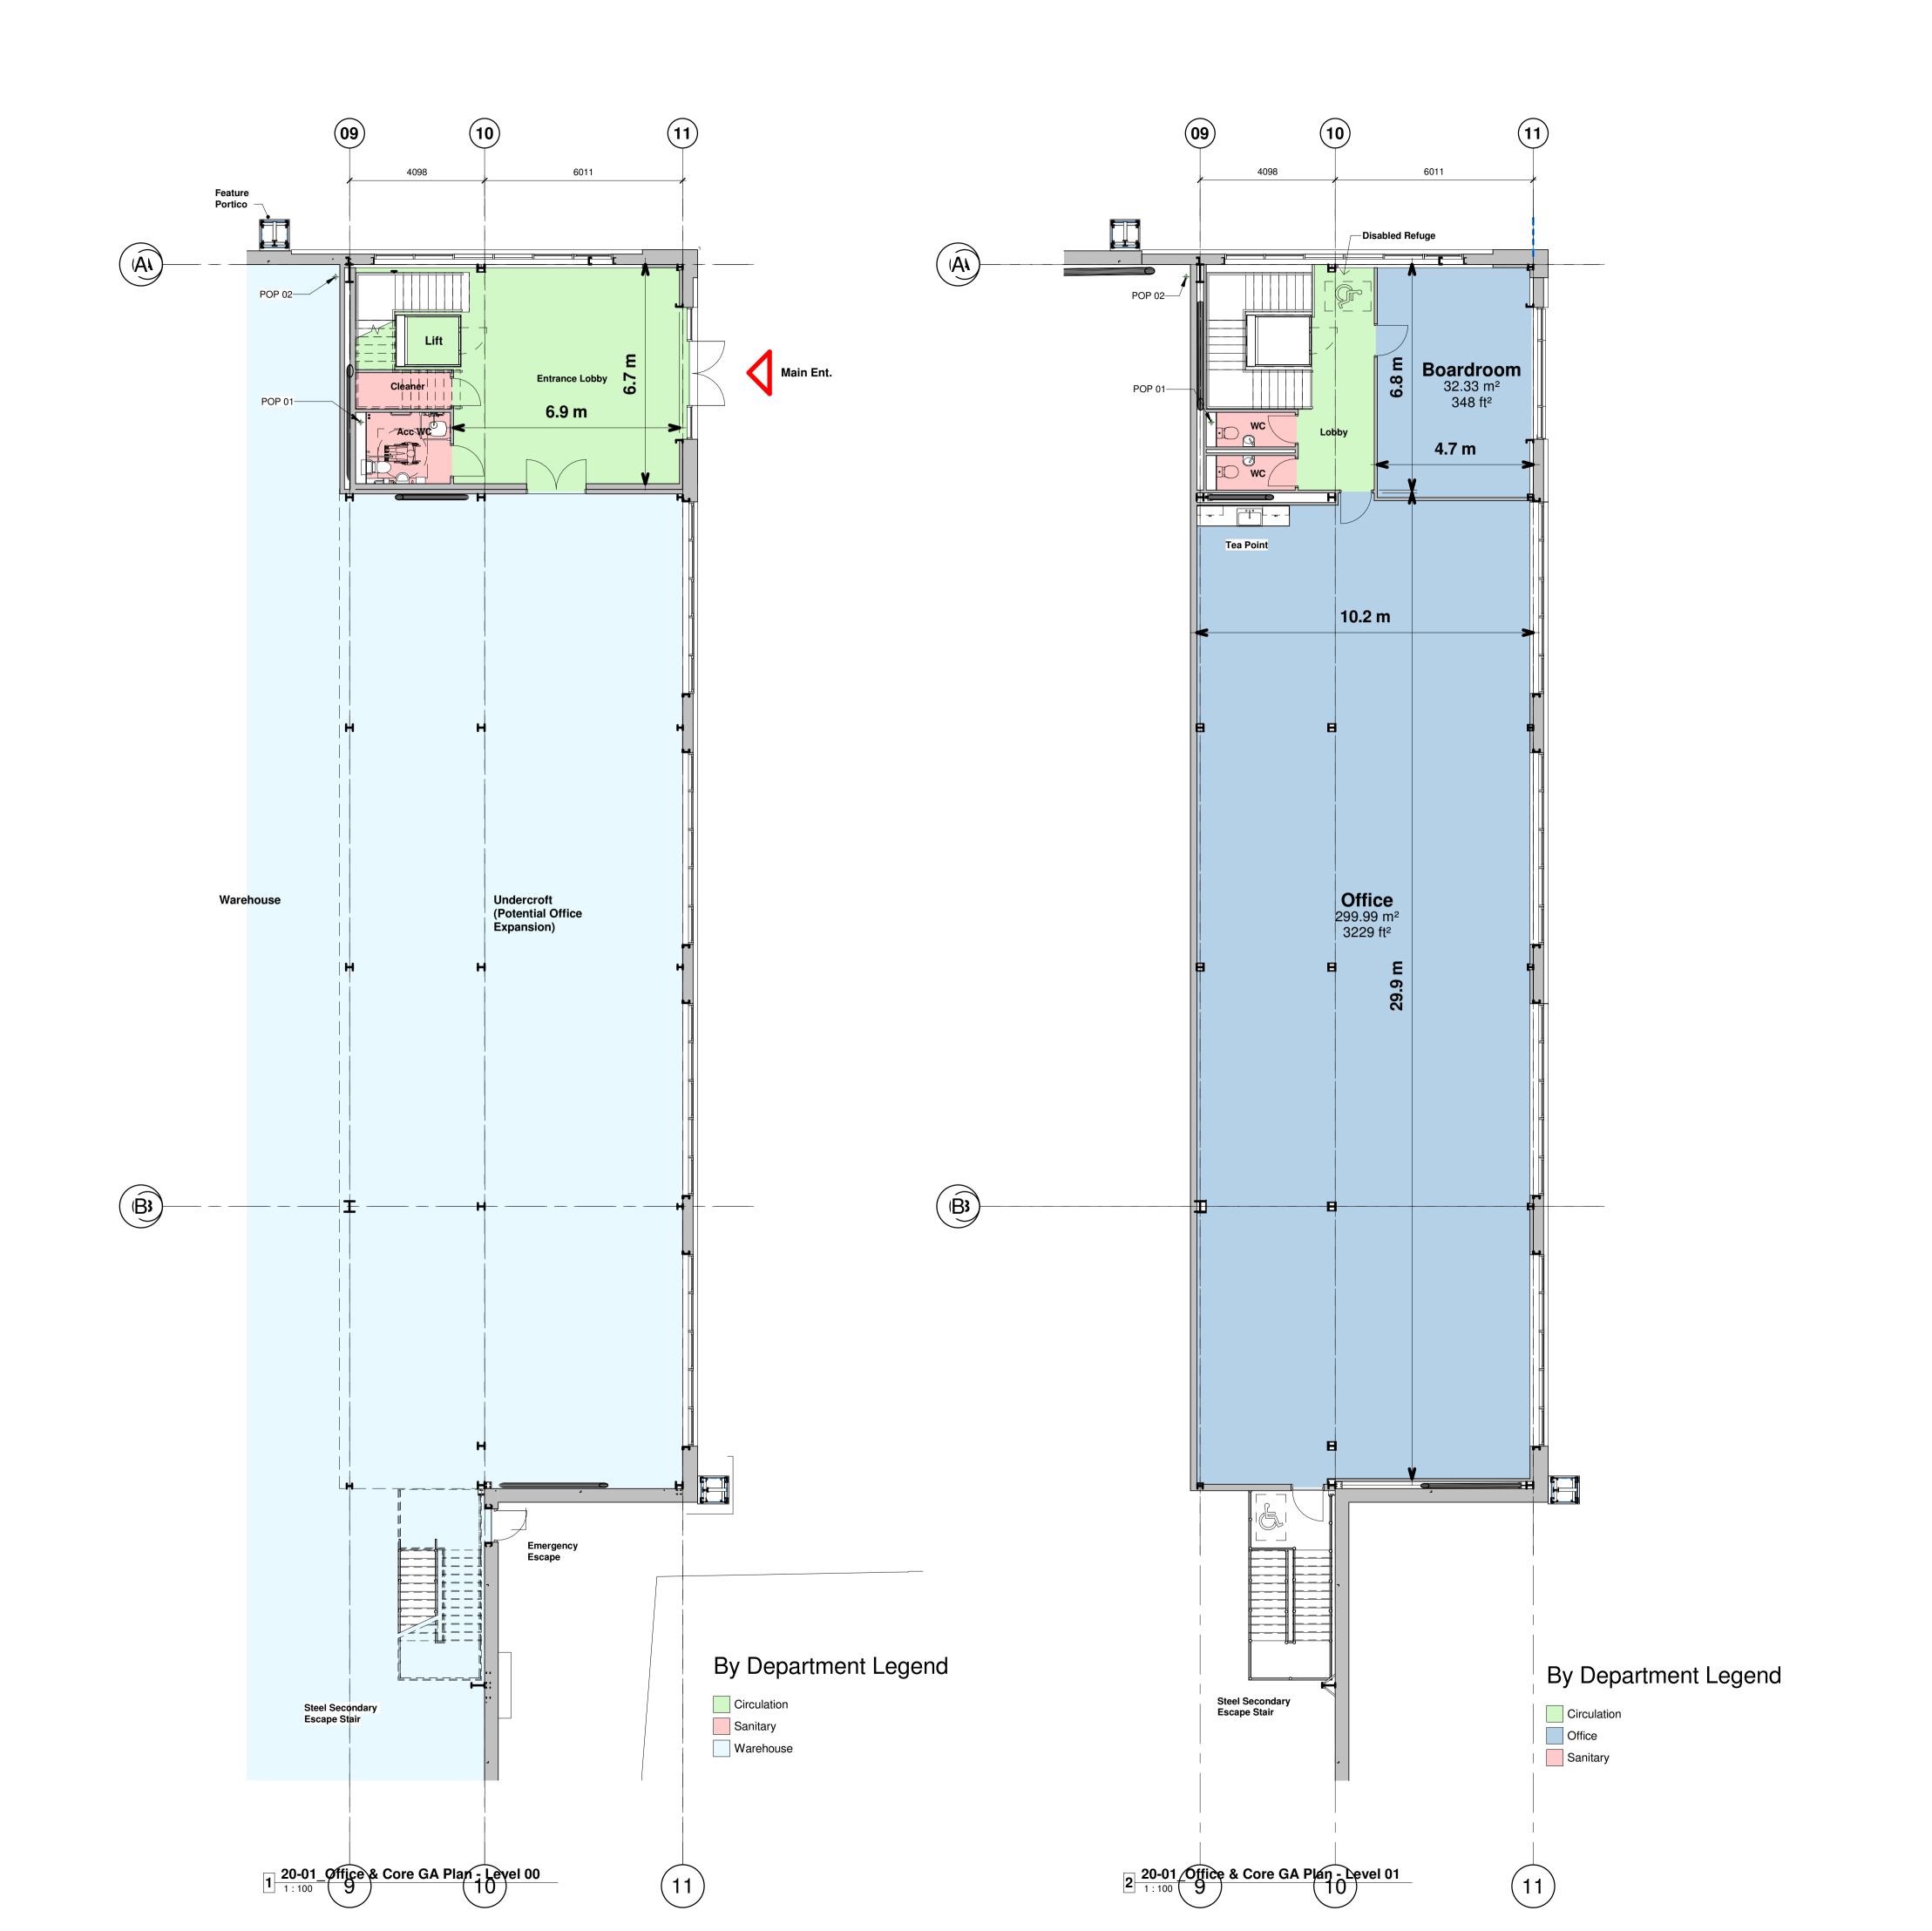
Client

GP Developments (Newbury) Limited

Project New Industrial Units Newbury

Drawing Title Unit 1 - Building GA Plan (Level 00)

Drawn by	BE	Create	d 0	4.11.21
C4 Job no.	21012	Scale	As indicated	@ A1
Drg no. 21012-C4	P-V1-ZZ-D	R-A-2	001	Rev C01



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)	VISUAI	_ SCALE 1	:200 @ /	A1	

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A Hazard Identification	
ref hazard	date
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PROJECT NOTES

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- Any proposed levels are indicative and subject to change to suit Engineered

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C01	Full Construction Issue	AW	13.09.22	SS
P8	Construction Issue	SS	01.08.22	
P7	General update. Contract Issue.	A.AL	28.06.22	SS
P6	PLANNING ISSUE. Notes amended as required by Planning.	A.AL	01.06.22	SS
P5	POP ups indicated.		25.05.22	
P4	Drawing naming correction.	SS	25.05.22	
P3	Minor structural co-ordination	SS	24.05.22	
P2	Layout & Areas updated.	A.AL	19.05.22	SS
P1	First Issue	SS	02.05.22	
Rev	Revision Details	Drawn	Date	Checked

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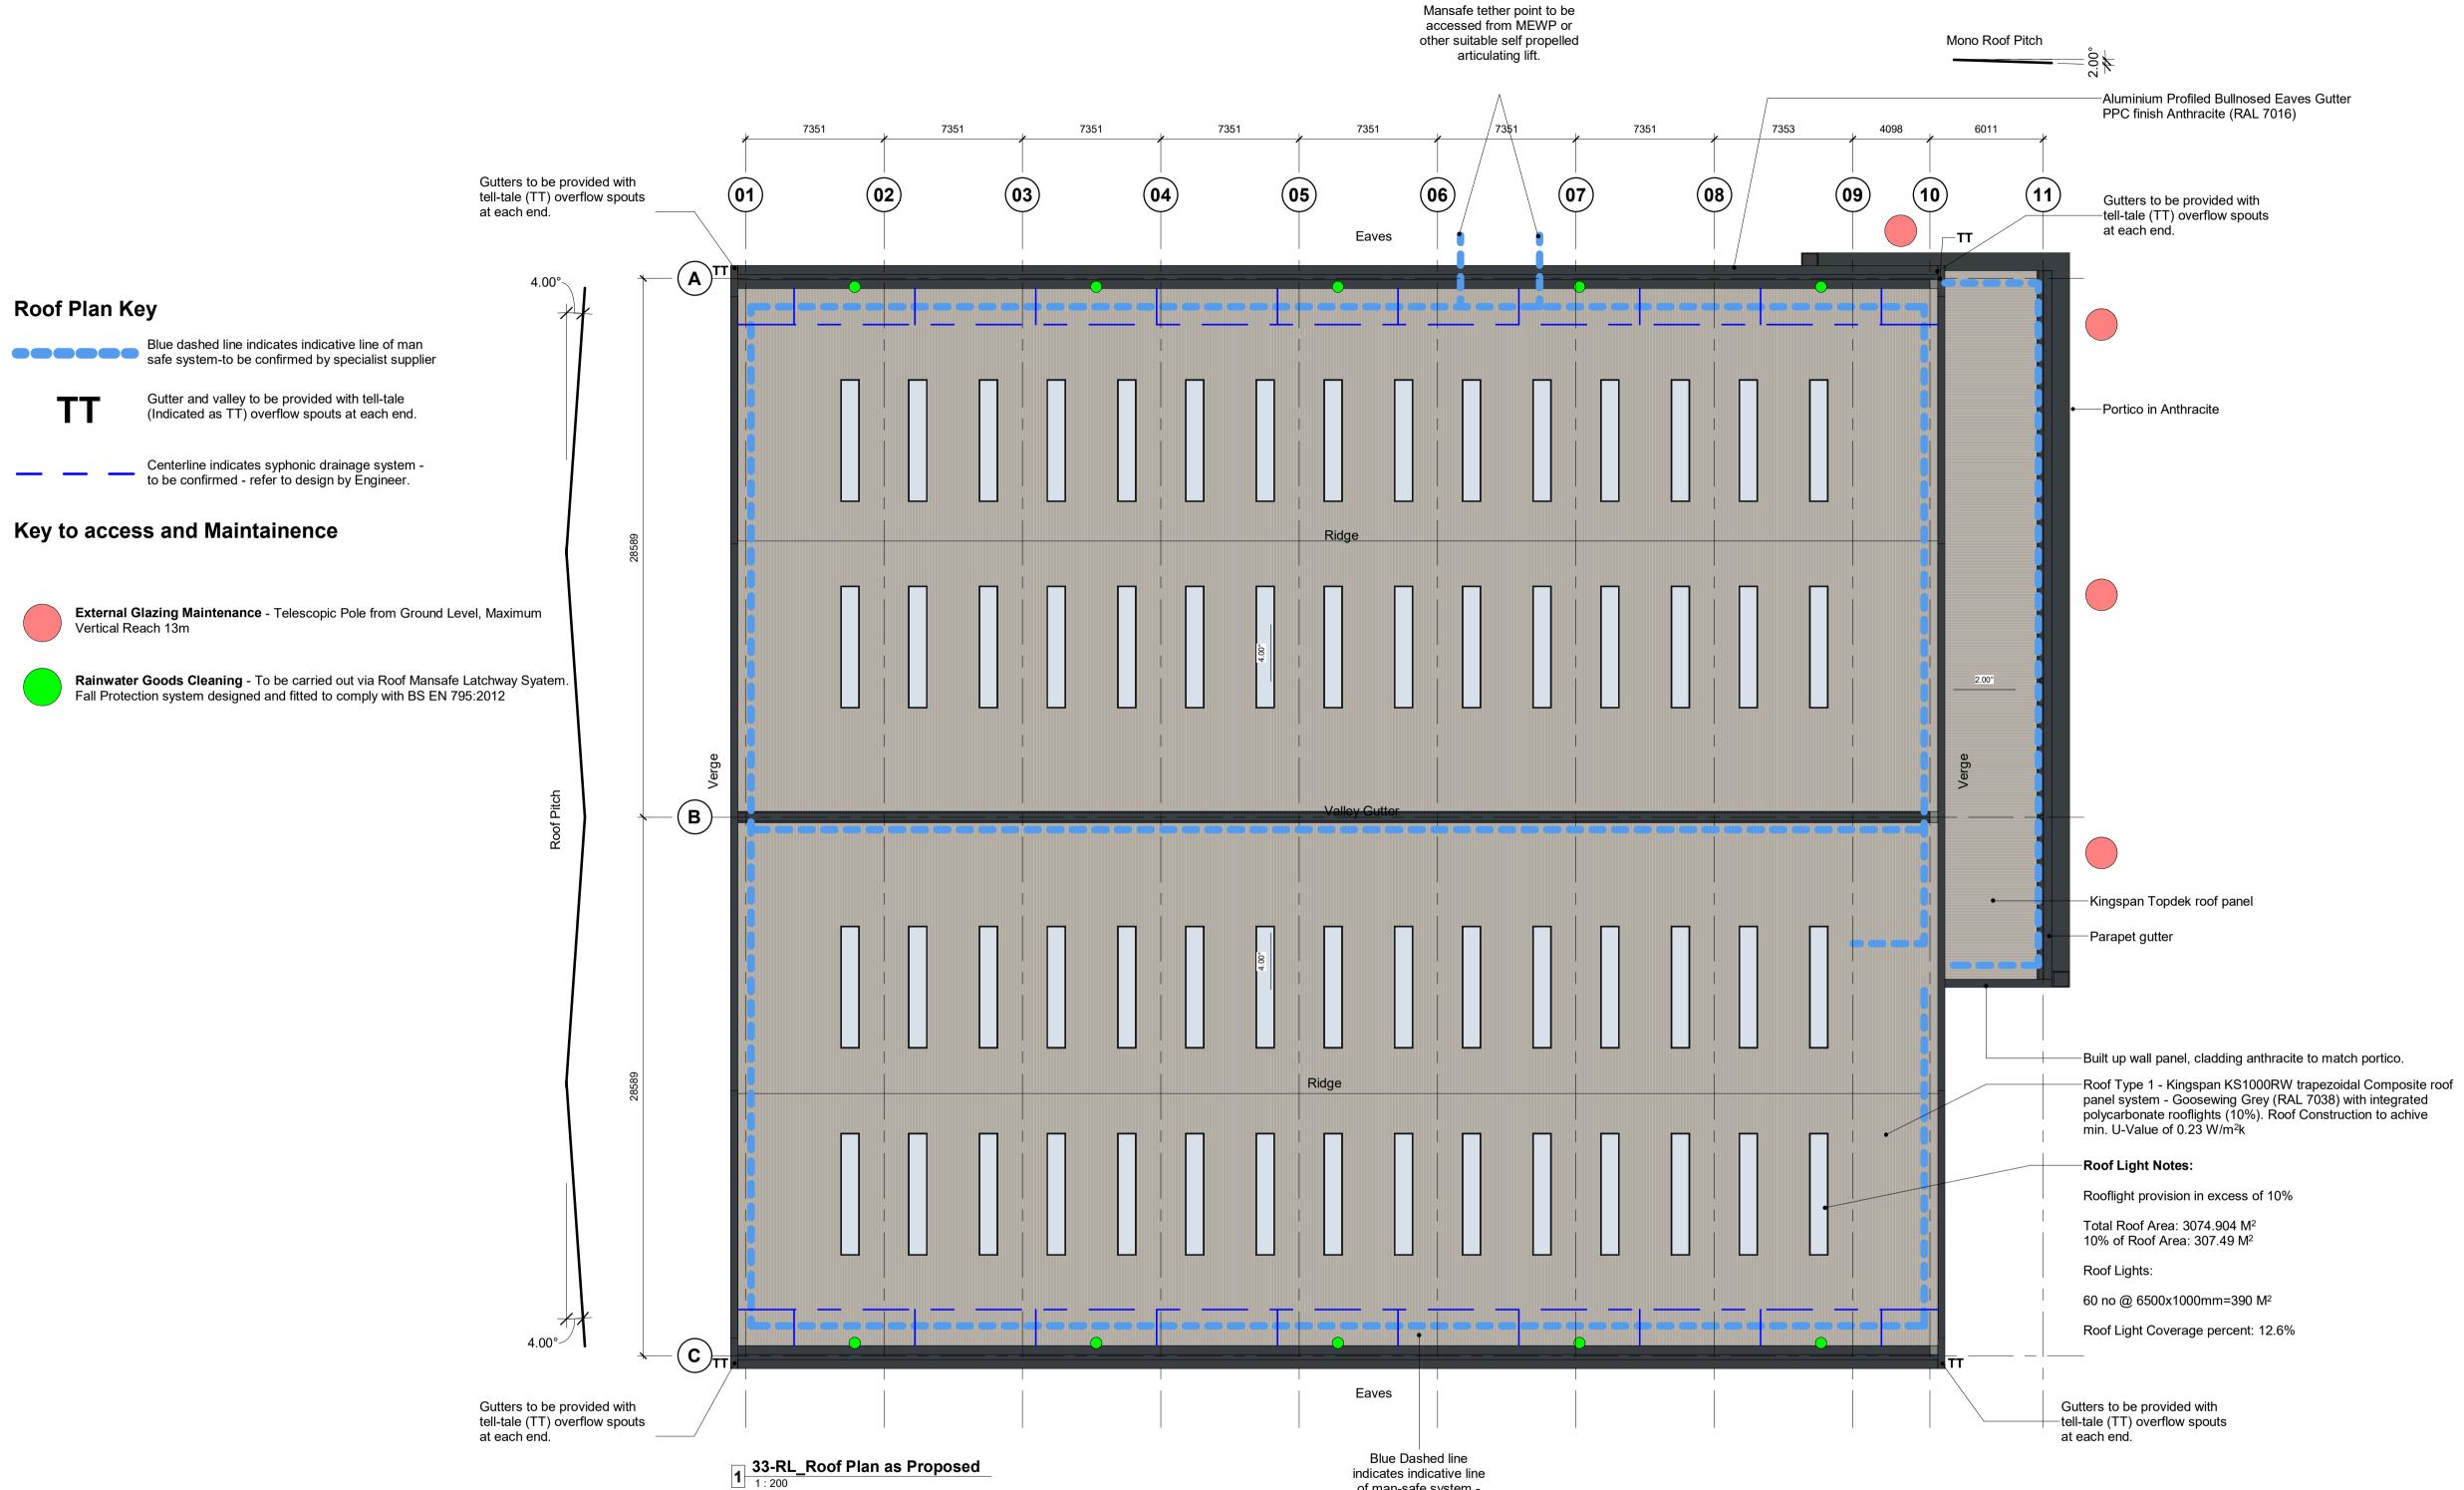
Client GP Developments (Newbury) Limited

Project New Industrial Units Newbury

Drawing Title

Unit 1 - Office & Core GA Plans (Levels 00 & 01)

Drawn by	SS	Create	02.05.22	
C4 Job no.	21012	Scale	As indicated	@ A1
Drg no. 21012-C4F	Drg no. 21012-C4P-V1-ZZ-DR-A-2002			Rev C01



of man-safe system to be confirmed by specialist supplier

N Ö

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			- 0			
Roo	flight Scher	lule				

Width

1000

Rough Height

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Hazard Identification	
ref hazard	date

PROJECT NOTES

rawing Status

- Design information indicated on this drawing is to be used 1 solely for **COORDINATION** purposes.
- Development proposals are to be read in conjunction with all referenced drawings and documents.
- Soft Landscaping shown is indicative, refer to Landscape Architect design for full details. 3.
- Any proposed levels are indicative and subject to 4. change to suit Engineered

U-VALUES, AIR PERMEABILITY & TESTING

U-VALUES Please refer to BRUKL calculations for further information

Calculate area-weighted average U-values External Walls 0.26 W/m²K Party Walls 0.26 W/m²K Ground Floor 0.22 W/m²K Roof 0.23 W/m²K External Personnel Doors 2.2 W/m²K Windows 1.6 W/m²K Curtain Wall 1.6 W/m²K Roller Shutters 1.5 W/m²K

AIR PERMEABILITY AND PRESSURE TESTING Reasonable provision shall be made to ensure the building is constructed to minimise unwanted air leakage through the new building fabric. The measured air permeability to be in compliance with the Target CO2 Emission Rate (TER) design limits. Air Permeability 5 m³/(hxm²) at 50 Pa

All buildings above 500 m² of total useful floor area must be subject to pressure testing

ADDITIONAL NOTES:

Only **non-combustible** materials are to be used on the building envelope

AW 13.09.22 SS C01 Full Construction Issue P7 Construction Issue SS 01.08.22 P6 General update. Contract Issue. A.AL 28.06.22 SS P5 PLANNING ISSUE. Notes amended as A.AL 01.06.22 SS required by Planning. P4 Unit size revised. Roof u-value and spec A.AL 24.05.22 SS updated. P3 Tender Issue BE 24.01.22 DC P2 Scale Note Amended BC 13.12.21 DC P1 First Issue of Drawing BE 16.11.21 DC Rev Revision Details Drawn Date Checked

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Client


GP Developments (Newbury) Limited

Project New Industrial Units Newbury

Drawing Title Unit 1 - Roof Plan as Proposed

Drawn by	BE	Create	d C)4.11.21
C4 Job no.	21012	Scale	As indicated	@ A1
Drg no. 21012-C4P	-V1-RL-D	R-A-3	301	Rev C01

Building Fabric Materials Schedule

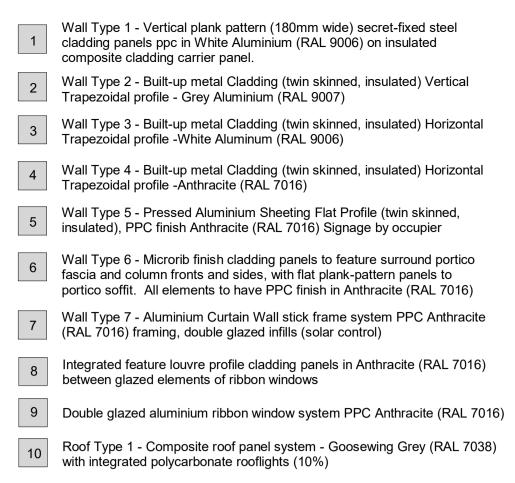



11 Feature recessed flashing detail in Anthracite (RAL 7016)

A Operational Door - Level Access Sectional insulated shutter, plastisol coated finish, Anthracite (RAL 7016)


- В Personnel Access / Escape doorset - Warehouse Galvanised steel, thermally insulated core, PPC Anthracite (RAL 7016)
- C Aluminium Pr (RAL 7016) Aluminium Profiled Bullnosed Eaves Gutter PPC finish Anthracite
- D Glazed Canopy above entrance by specialist contractor

Note: Internal Siphonic Drainage System to be installed. Maximum roof height to be no more than 14m. Portal Frame to be pre-set in fabrication to 4degrees.

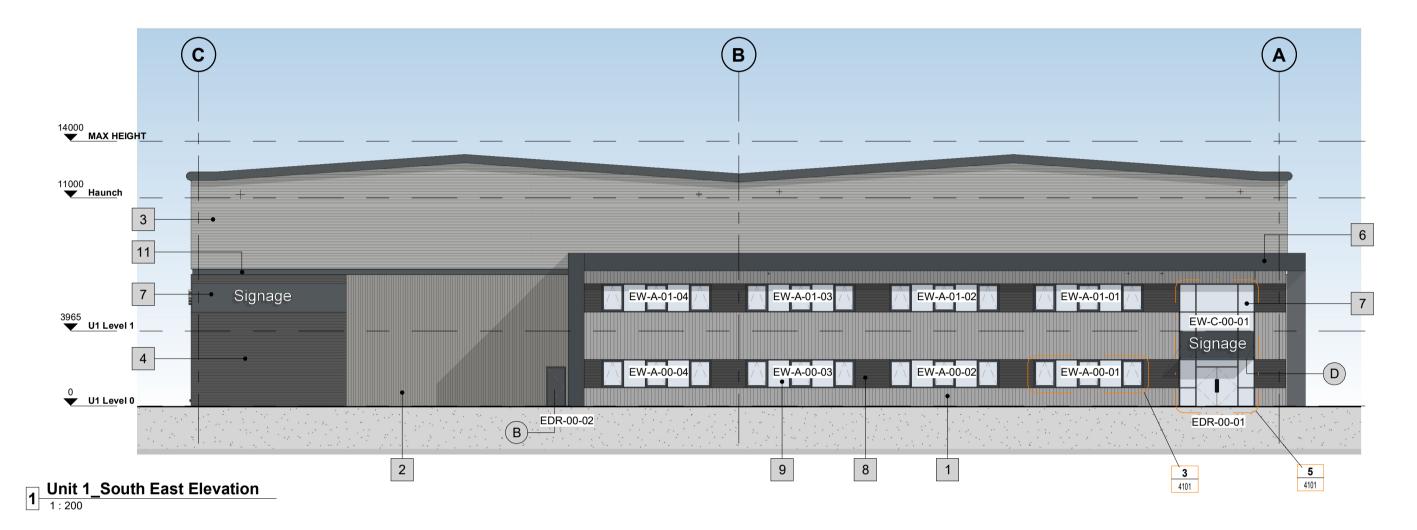

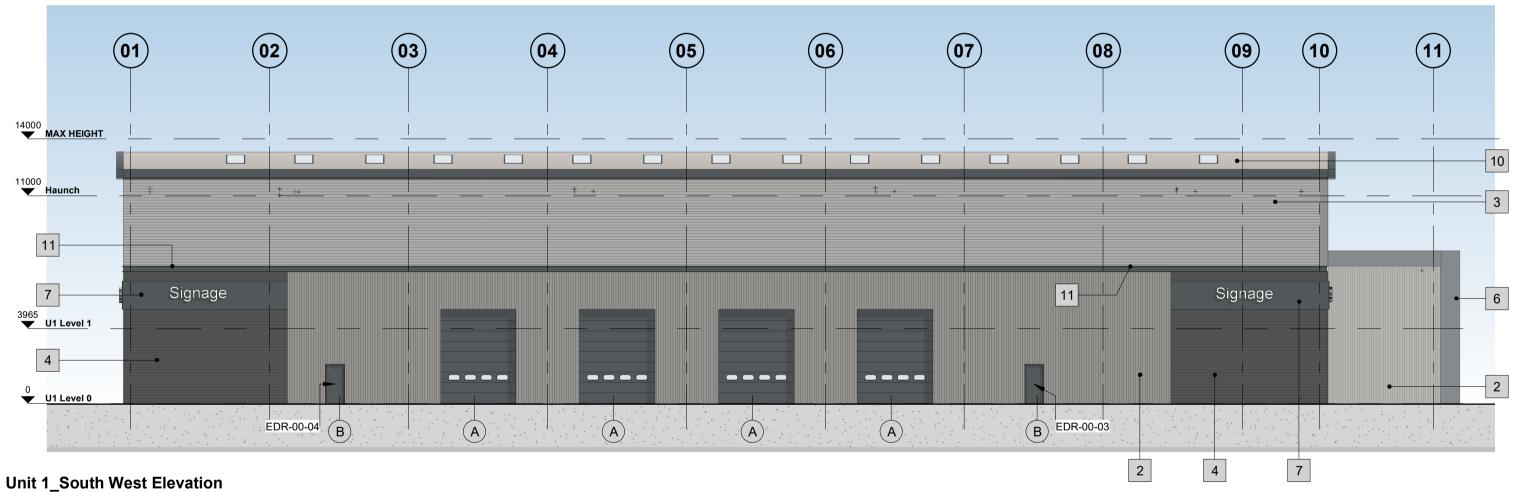

Unit 1_South West Elevation

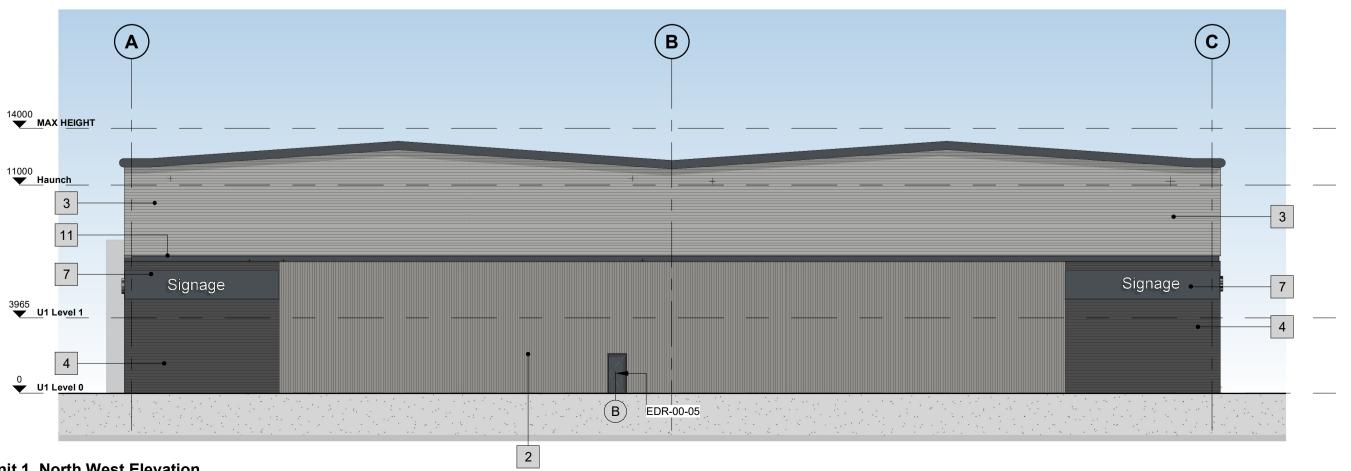

4 Unit 1_North West Elevation

U-VALUES, AIR PERMEABILITY & TESTING

U-VALUES Please refer to BRUKL calculations for further information

Calculate area-weighted average U-values (N.B: Actual U Values may exceed these target values) External Walls 0.26 W/m²K Party Walls 0.26 W/m²K Ground Floor 0.22 W/m²K


Roof 0.23 W/m²K External Personnel Doors 2.2 W/m²K Windows 1.6 W/m²K Curtain Wall 1.6 W/m²K Roller Shutters 1.5 W/m²K


AIR PERMEABILITY AND PRESSURE TESTING Reasonable provision shall be made to ensure the building is constructed to minimise unwanted air leakage through the new building fabric. The measured air permeability to be in compliance with the Target CO2 Emission Rate (TER) design limits.

Air Permeability 5 m³/(hxm²) at 50 Pa All buildings above 500 m² of total useful floor area must be subject to pressure testing

ADDITIONAL NOTES:

Only **non-combustible** materials are to be used on the building envelope

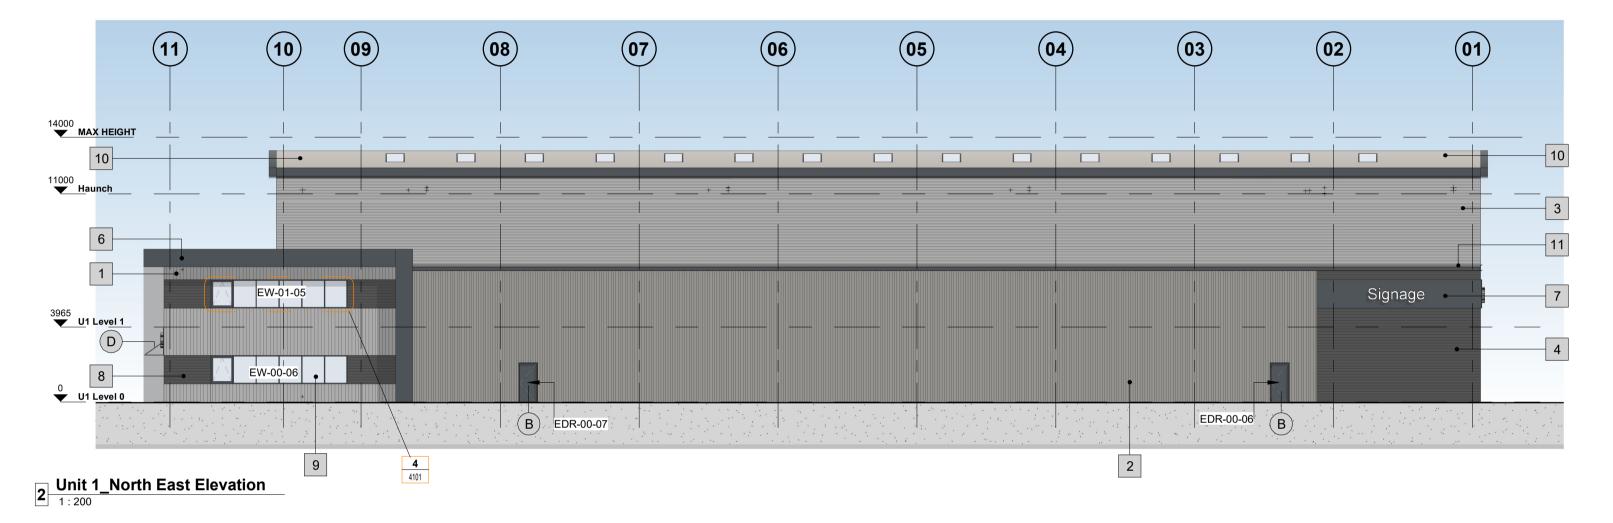

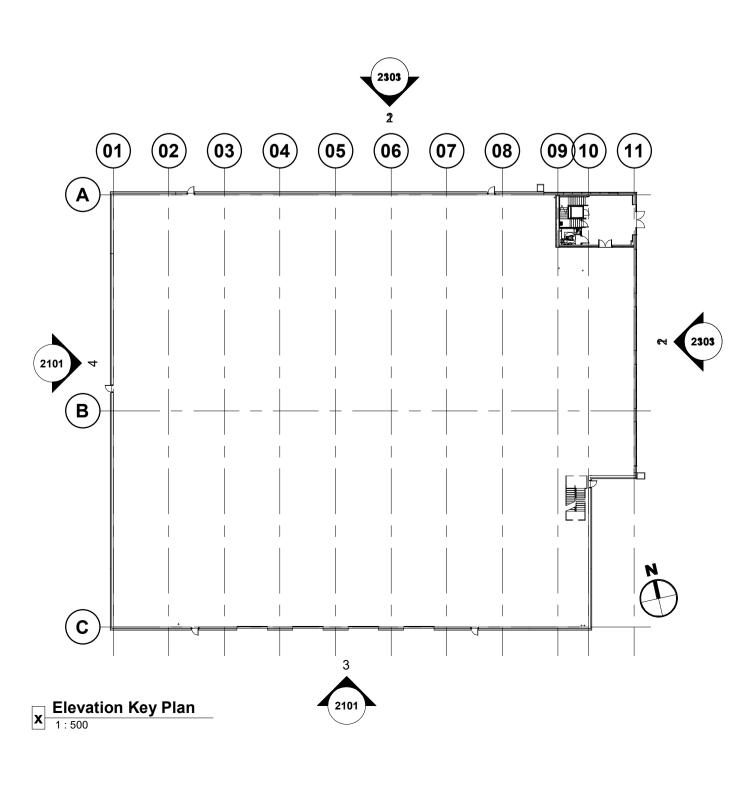

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PROJECT NOTES

- 1. Development proposals are to be read in conjunction with all referenced drawings and documents.
- Soft Landscaping shown is indicative, refer to Landscape 2 Architect design for full details. Any proposed levels are indicative and subject to
- change to suit Engineered solution. Refer to Civil Engineer's designs.

wing Status	
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Azard Identification ref hazard

date

	C03	Cladding updated per client requirements	SS	26.01.23	
	C02	First Floor Slab Height Updated	GN	18.11.22	SS
	C01	Full Construction Issue	AW	13.09.22	SS
	P8	Construction Issue	SS	01.08.22	
	P7	General update. Contract Issue.	A.AL	28.06.22	SS
	P6	PLANNING ISSUE. Notes amended as required by Planning.	A.AL	01.06.22	SS
	P5	SE Co-ordination and Specifications Update.	A.AL	27.04.22	SS
	P4	Elevations Updated.	A.AL	21.04.22	SS
	P3	Tender Issue	BE	24.01.22	DC
	P2	Scale Note Amended	BC	13.12.21	DC
	P1	First Issue of Drawing	BE	16.11.21	DC
[Rev	Revision Details	Drawn	Date	Checked

Wilderspool Business Park Stockton Heath, WA4 6HL t: 01925 751 852 Projects e: info@c4projects.co.uk www.c4projects.co.uk Architecture • Building Surveying • Cost C

Client

GP Developments (Newbury) Limited

Project New Industrial Units Newbury

Drawing Title

Unit 1 - Elevations as Proposed


Status Purpose of Issue B PARTIALLY SIGNED-OFF						
Drawn by	BE	Created	04.11.21			
C4 Job no.	21012	Scale As indica	ted @ A1			
Drg no. 21012-C4	P-V1-ZZ-D	R-A-2101	Rev C03			

Building Fabric Materials Schedule


- 1 Wall Type 1 Built-up metal Cladding (twin skinned, insulated) Western Red Cedar Finish 2 Wall Type 2 - Built-up metal Cladding (twin skinned, insulated) Vertical Trapezoidal profile - Grey Aluminium (RAL 9007) 3 Wall Type 3 - Built-up metal Cladding (twin skinned, insulated) Horizontal Trapezoidal profile -White Aluminum (RAL 9006)
- 4 Wall Type 4 Aluminium Curtain Wall stick frame system PPC Anthracite (RAL 7016) framing, double glazed infills (solar control)
- Wall Type 5 Pressed Aluminium Sheeting Flat Profile (twin skinned, insulated), PPC finish Anthracite (RAL 7016) Signage by occupier 5 Wall Type 6 - Pressed Aluminium Sheeting to Feature Surround Flat faced panels (uninsulated), open joints, PPC finish
- 6 Anthracite (RAL 7016)
- 7 Feature recessed detail flashing Anthracite (RAL 7016)
- 8 Integrated timber louvre system - to match timber cladding
- 9 Double glazed aluminium ribbon window system PPC Anthracite (RAL 7016)
- 10 Roof Type 1 Composite roof panel system Goosewing Grey (RAL 7038) with integrated polycarbonate rooflights (10%)

- A Operational Door Level Access Sectional insulated shutter, plastise Sectional insulated shutter, plastisol coated finish, Anthracite (RAL 7016)
- B Personnel Access / Escape doorset Warehouse Galvanised steel, thermally insulated core, PPC Anthracite (RAL 7016)
- С Aluminium Profiled Bullnosed Eaves Gutter PPC finish Anthracite (RAL 7016)
- D Glazed Canopy above entrance.
 - Note: Internal Siphonic Drainage System to be installed Maximum roof height to be no more than 14m


Portal Frame to be pre-set in fabrication to 4degrees.

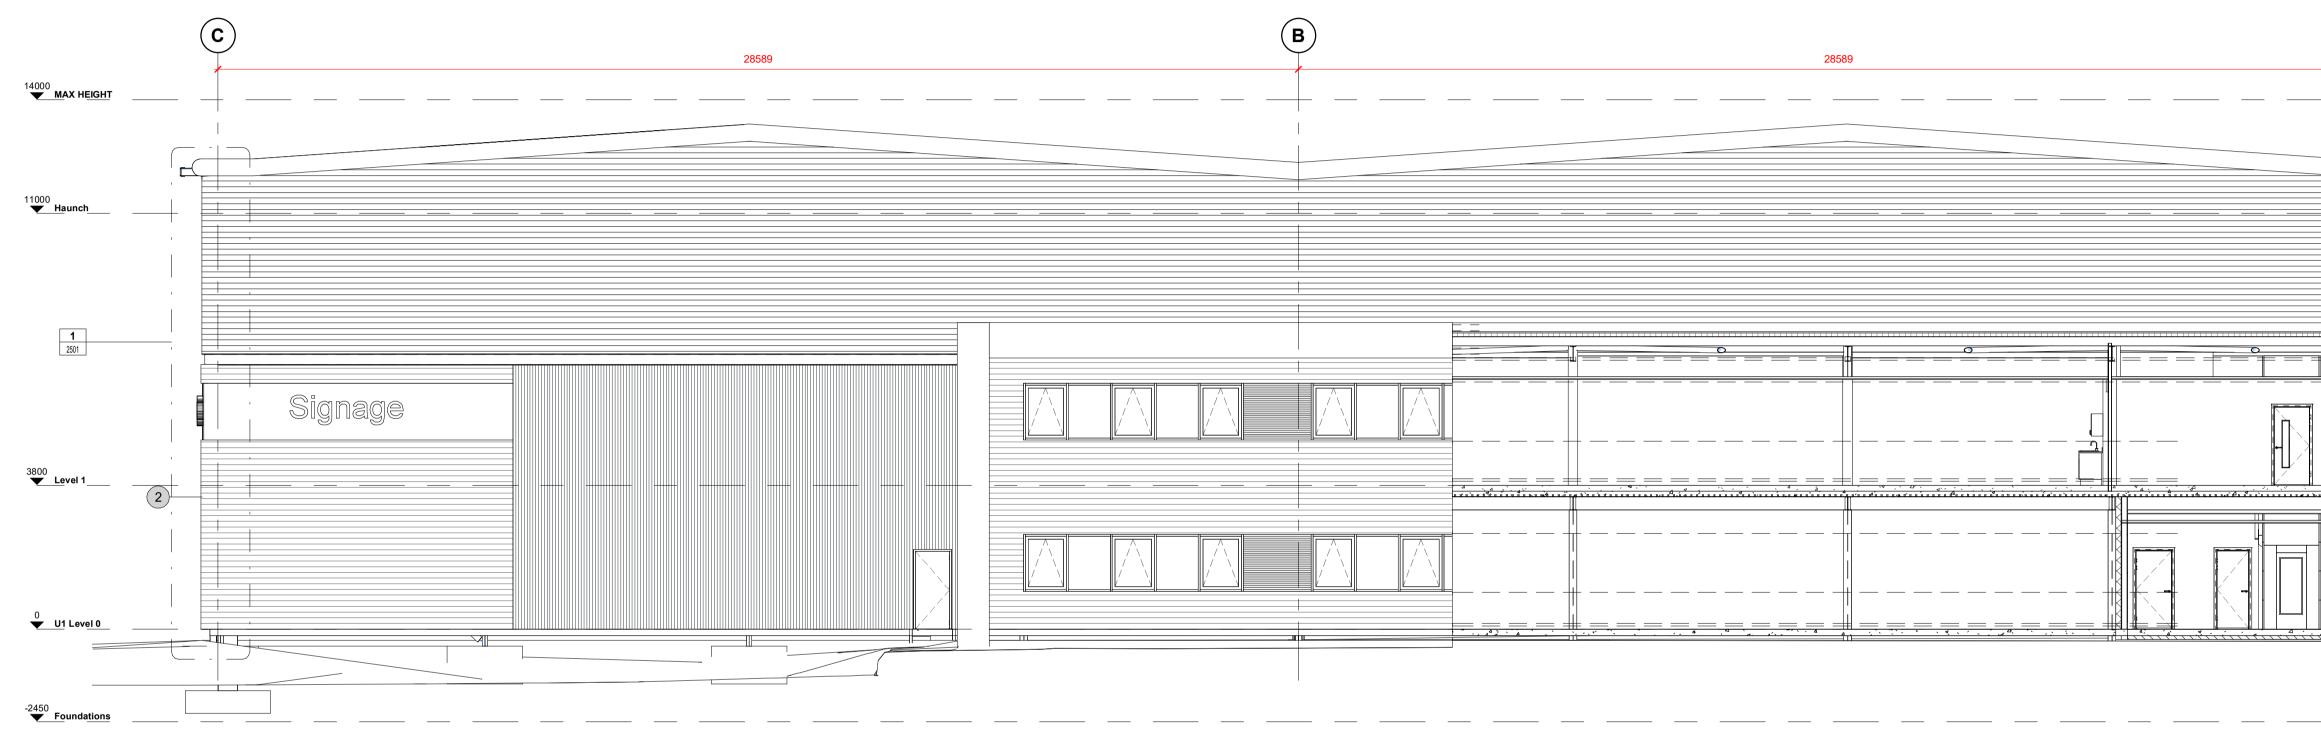


A SECTION A

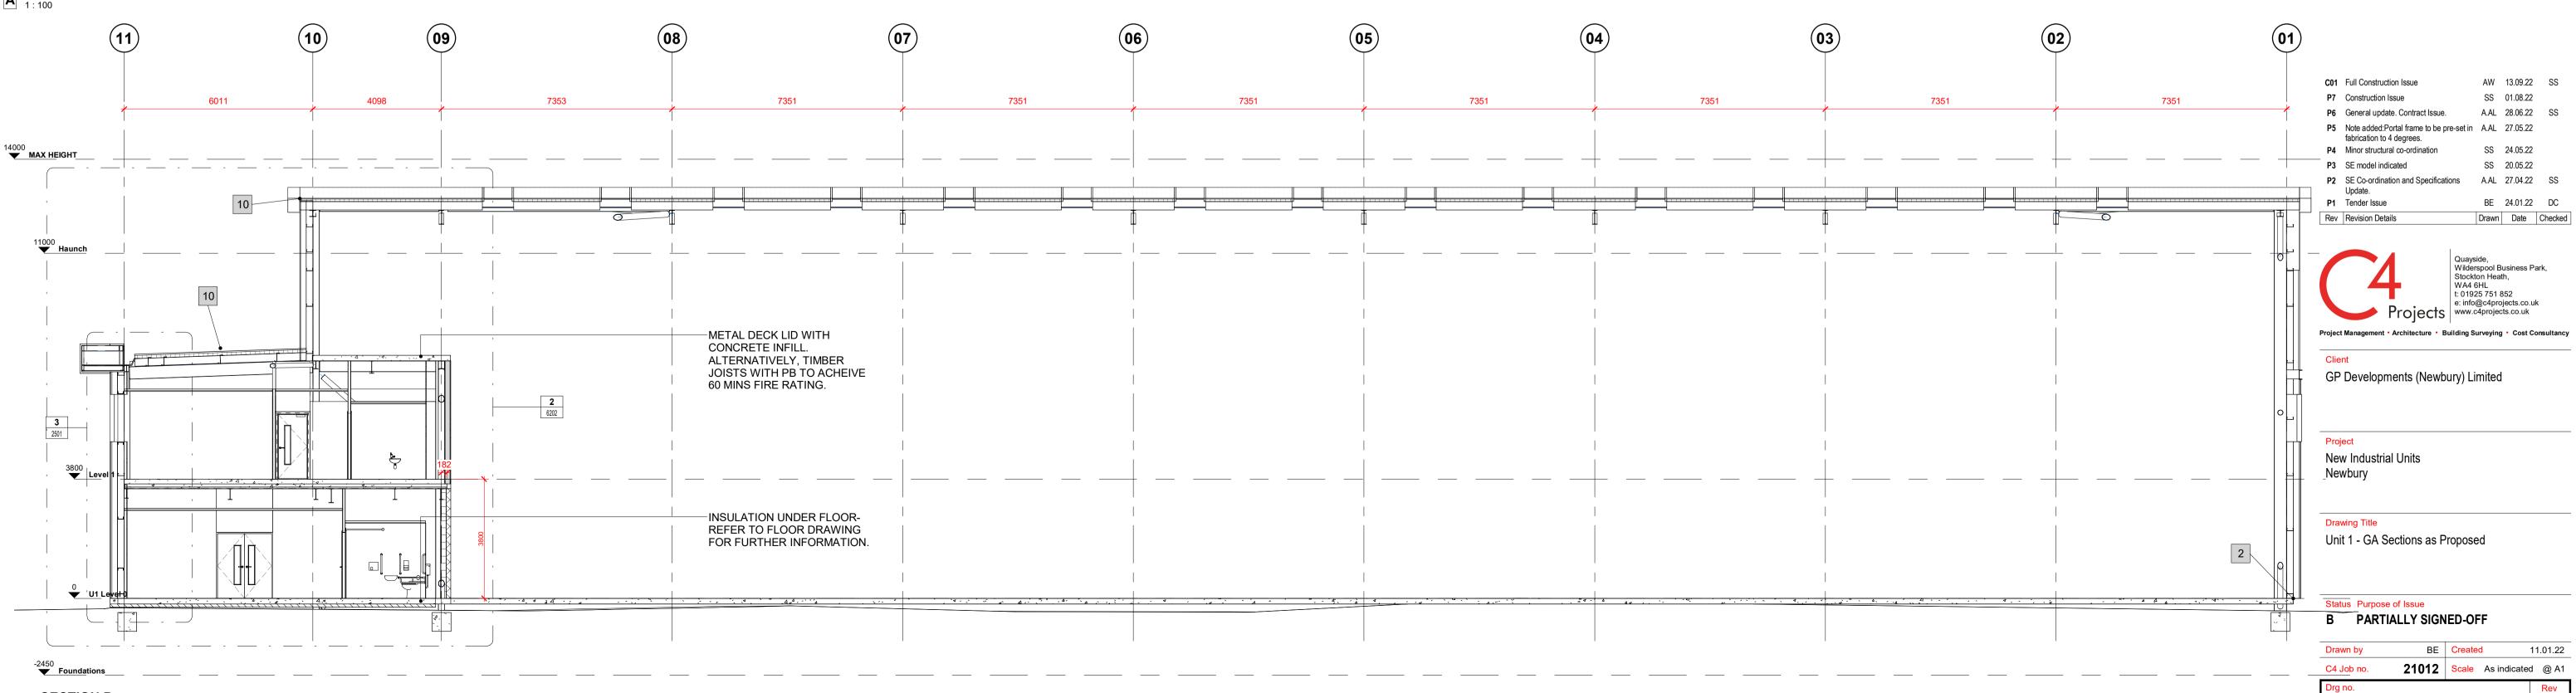

B SECTION B 1 : 100

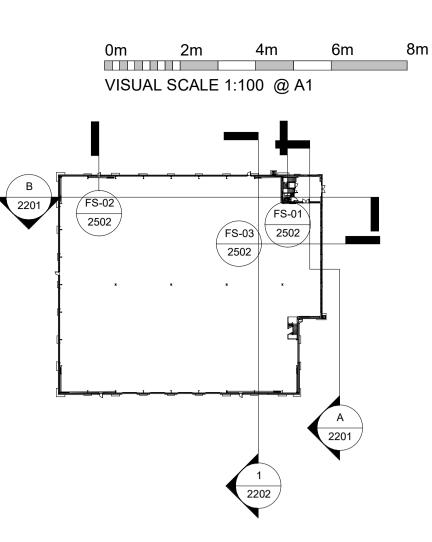

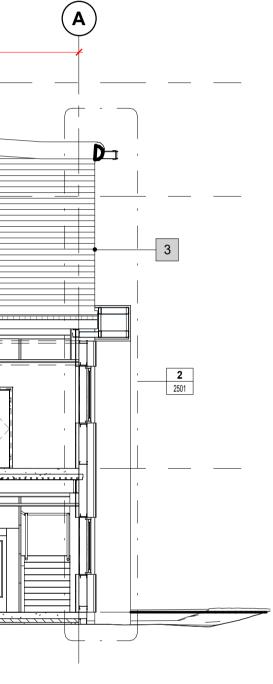

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- Soft Landscaping shown is indicative, refer to Landscape 3. Architect design for full details.
- Any proposed levels are indicative and subject to 4. change to suit Engineered

U-VALUES, AIR PERMEABILITY & TESTING

U-VALUES Please refer to BRUKL calculations for further information

Calculate area-weighted average U-values External Walls 0.26 W/m²K Party Walls 0.26 W/m²K Ground Floor 0.22 W/m²K Roof 0.23 W/m²K External Personnel Doors 2.2 W/m²K Windows 1.6 W/m²K Curtain Wall 1.6 W/m²K Roller Shutters 1.5 W/m²K

AIR PERMEABILITY AND PRESSURE TESTING Reasonable provision shall be made to ensure the

building is constructed to minimise unwanted air leakage through the new building fabric. The measured air permeability to be in compliance with the Target CO2 Emission Rate (TER) design limits. Air Permeability 5 m³/(hxm²) at 50 Pa


All buildings above 500 m² of total useful floor area must be subject to pressure testing

ADDITIONAL NOTES:

Only **non-combustible** materials are to be used on the building envelope

21012-C4P-V1-ZZ-DR-A-2201

C01

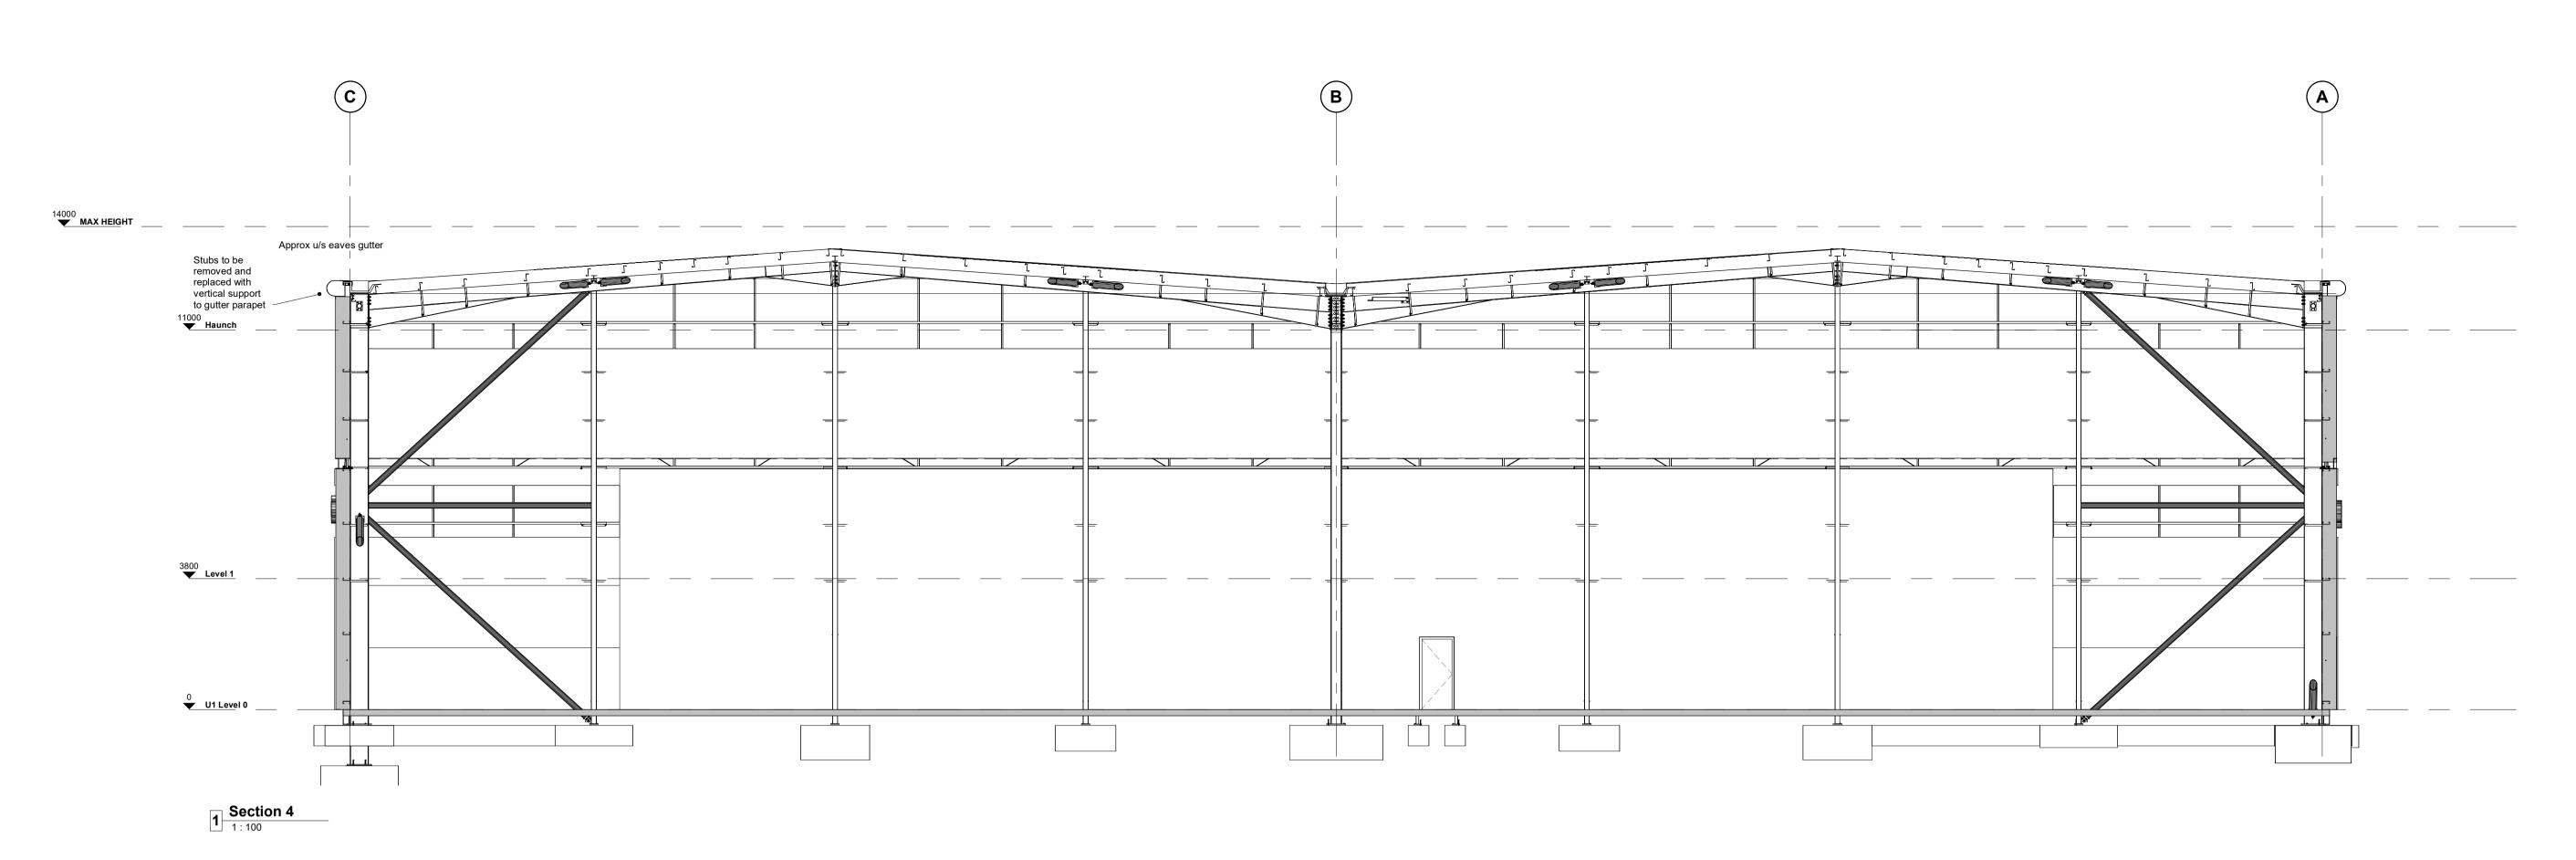

U-VALUES, AIR PERMEABILITY & TESTING

U-VALUES Please refer to BRUKL calculations for further information

Calculate area-weighted average U-values External Walls 0.26 W/m²K Party Walls 0.26 W/m²K Ground Floor 0.22 W/m²K Roof 0.23 W/m²K External Personnel Doors 2.2 W/m²K Windows 1.6 W/m²K

Curtain Wall 1.6 W/m²K Roller Shutters 1.5 W/m²K


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Air Permeability 5 m³/(hxm²) at 50 Pa All buildings above 500 m² of total useful floor area

must be subject to pressure testing

ADDITIONAL NOTES:

Only **non-combustible** materials are to be used on the building envelope

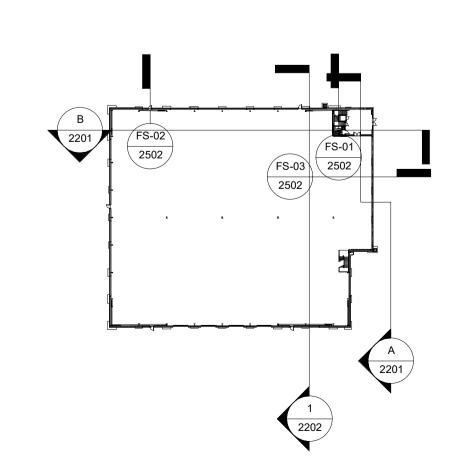

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PROJECT NOTES

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- Development proposals are to be read in conjunction with all referenced drawings and documents.
- Soft Landscaping shown is indicative, refer to Landscape Architect design for full details.
- Any proposed levels are indicative and subject to change to suit Engineered

REFERENCE DRAWINGS

Architectural 21017-C4P-;

Refer to 01 Series for Existing Site Refer to 04 Series for Proposed Masterplan Site Refer to 05 Series for Proposed Site Refer to 86 Series for Proposed Site Demises
Refer to 20 Series for Building GA Plans Refer to 21 Series for Building GA Elevations Refer to 22 Series for Building GA Sections Refer to 23 Series for Setting Out Refer to 23 Series for RCPs Refer to 25 Series for Detailed Sections Refer to 30 Series for Floor Types Refer to 30 Series for Internal Partitions Refer to 33 Series for Roof Plan Refer to 34 Series for Main Staircore and Secondary Escape Stair Refer to 40 Series for Proposed Curtain Wall and Ribbon Windows Refer to 42 Series for Glazed Entrance Canopy Details Refer to 43 Series for External Door Schedules Refer to 44 Series for Internal Door Schedules Refer to 50 Series for Finishes Plans
Refer to 62 Series for Fire Strategy Refer to 71 Series for Accessible WC (Typical) Refer to 72 Series for Office Tea Point

C01	Full Construction Issue		AW	13.09.22	SS
P2	Construction Issue		SS	01.08.22	
P1	General update. Contract Issue.		A.AL	28.06.22	SS
Rev	Revision Details		Drawn	Date	Checked
		Quavs	ide		

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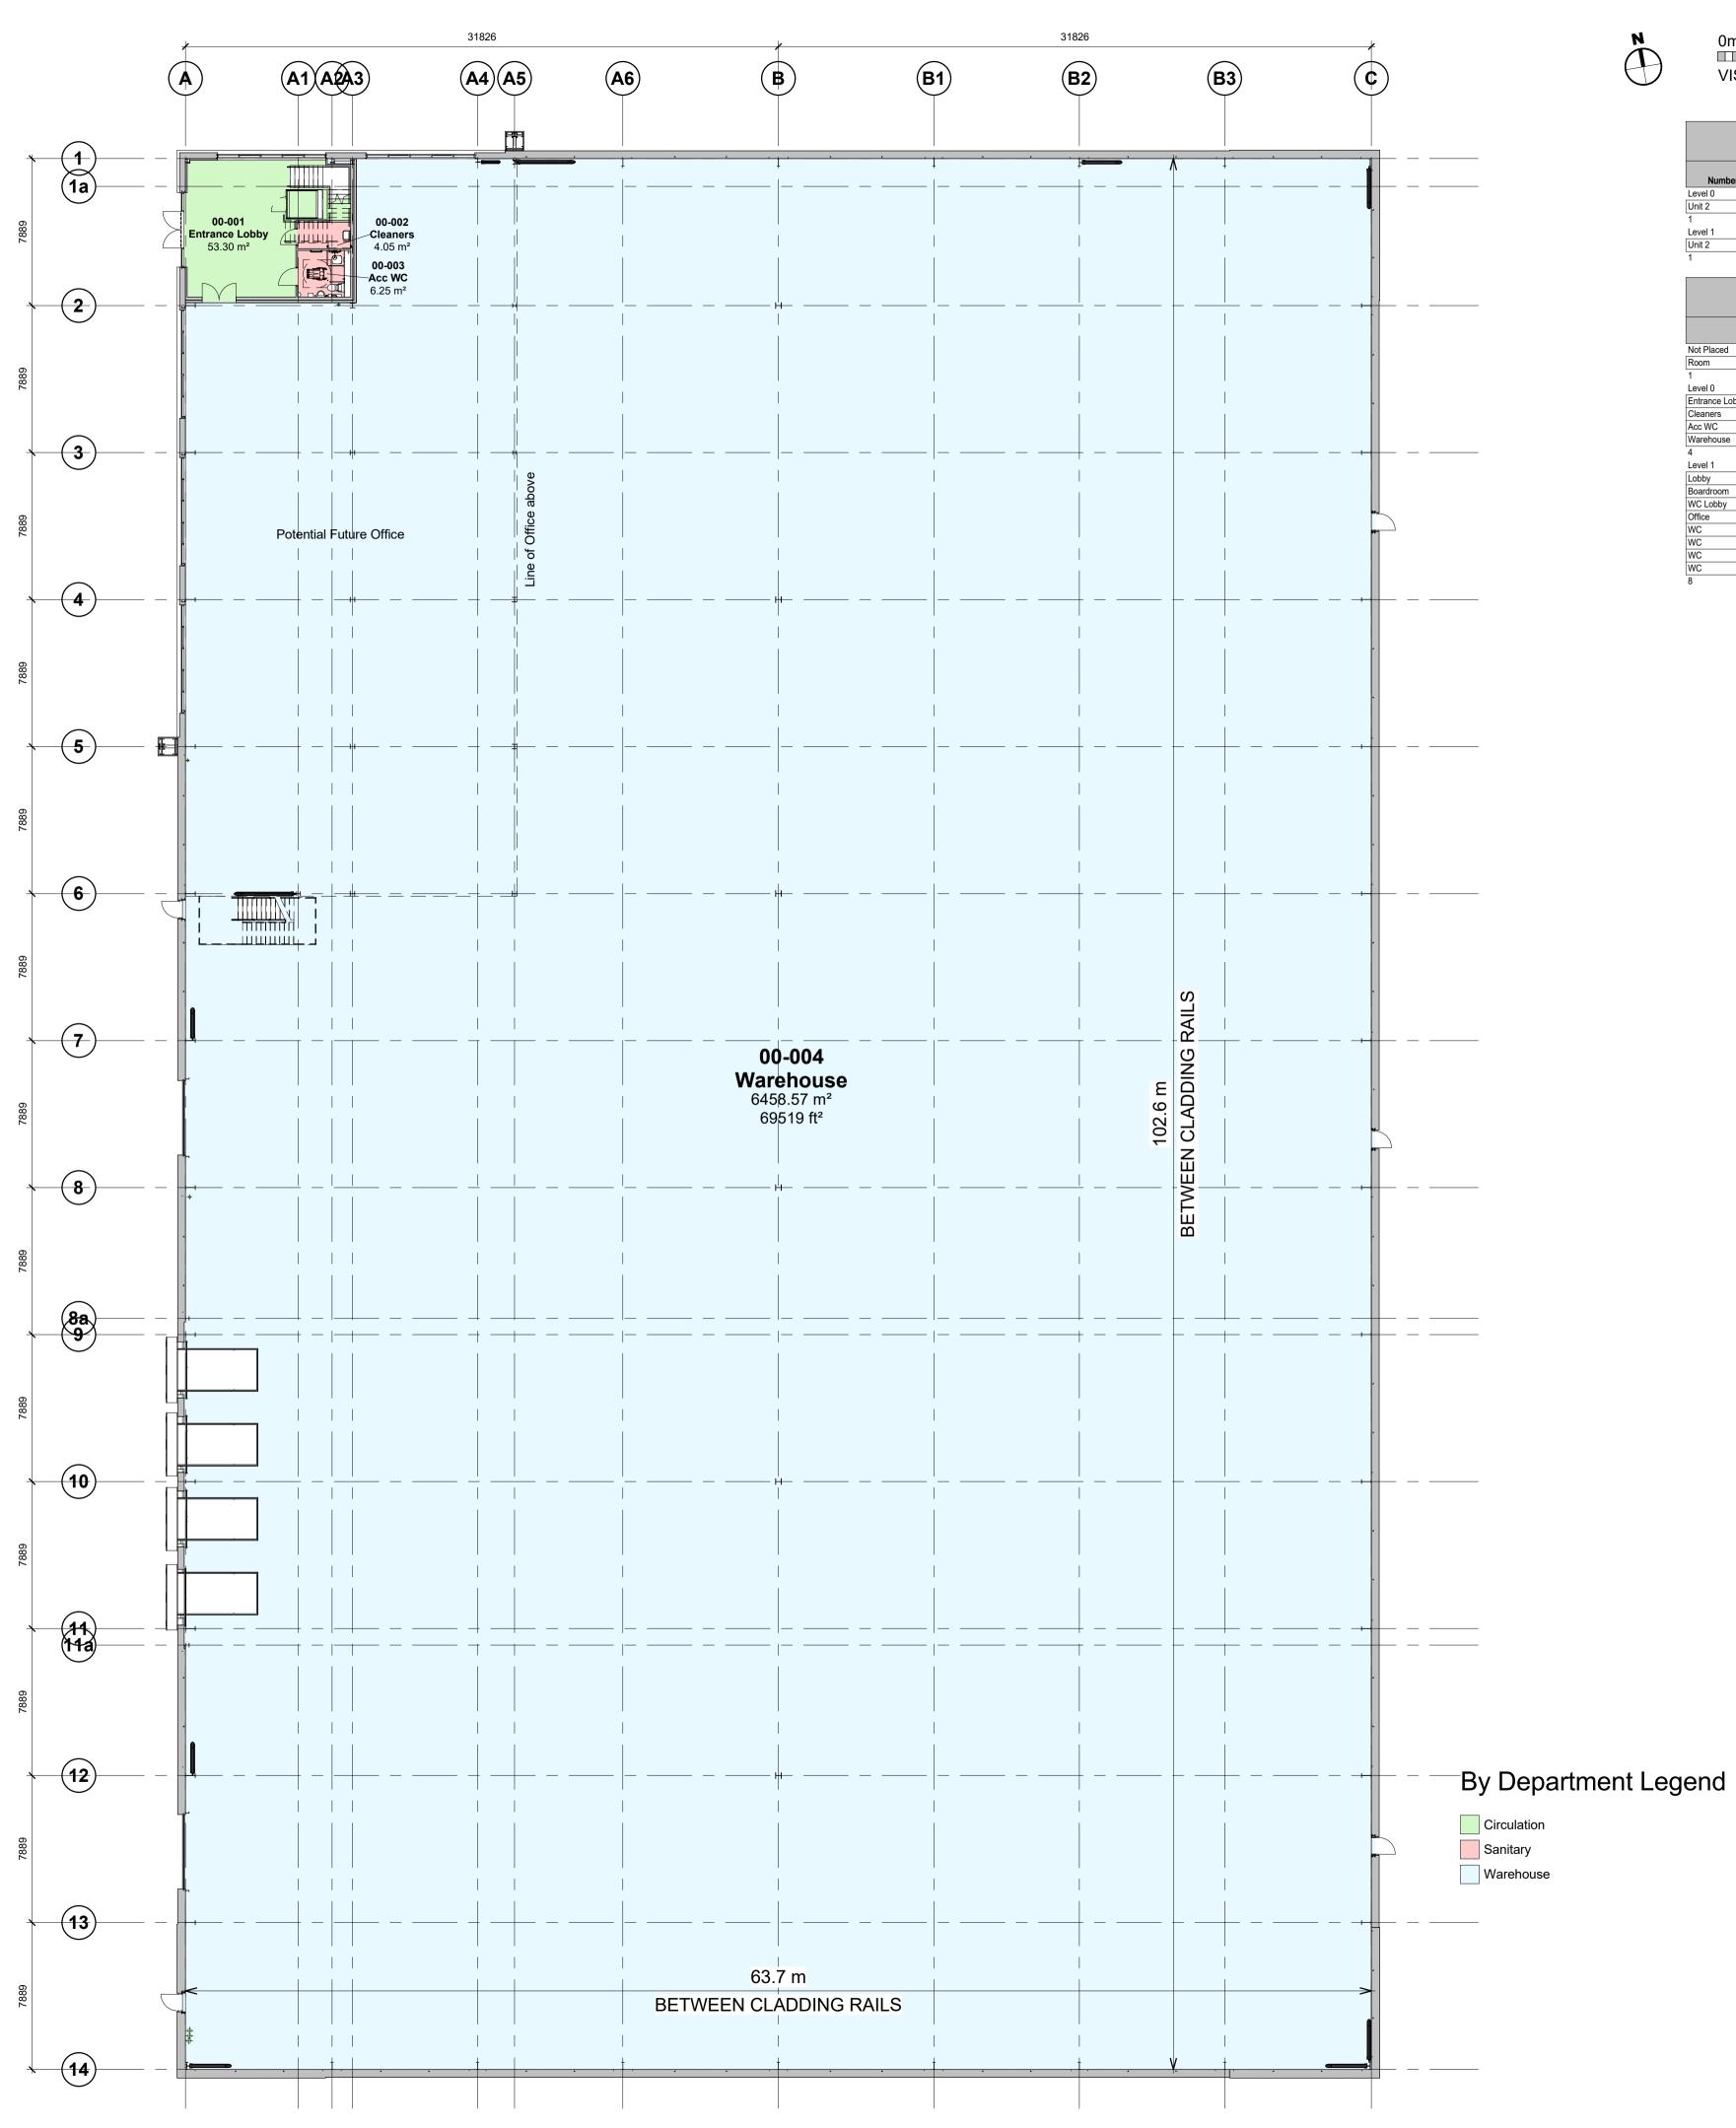
Client GP Developments (Newbury) Limited

Project New Industrial Units Newbury

Drawing Title Unit 1 - GA Sections (Sheet 2)

Status Purpose of Issue B PARTIALLY SIGNED-OFF

Drawn by	SS	Create	d .	23.06.22
C4 Job no.	21012	Scale	As indicated	d @ A1
Drg no. 21012-C4	P-V1-ZZ-D	R-A-2 :	202	Rev C01



1 20-00_Building GA Plan (Level 00)

16m 8m 12m 0m 4m VISUAL SCALE 1:200 @ A1

Are	ea Schedule (GIA)	
	Ar	ea
nber Name	Metric	Imperial
GF GIA	0 500 052	70 007 #
GF GIA	6,528.05 m ²	70,267 ft
	6,528.05 m²	70,267 ft
FF GIA	685.53 m ²	7,379 ft ²
	685.53 m²	7,379 ft ²
Name	Areas	-
Name	Metric	Imperial
ed		
ed	Not Placed	
ed	Not Placed 0.00 m ²	0 ft²
ed		0 ft² 574 ft²
	0.00 m ²	
	0.00 m ²	574 ft²
	0.00 m ² 53.30 m ² 4.05 m ²	574 ft ² 44 ft ² 67 ft ²
Lobby	0.00 m ² 53.30 m ² 4.05 m ² 6.25 m ²	574 ft ² 44 ft ²
Lobby	0.00 m ² 53.30 m ² 4.05 m ² 6.25 m ² 6,458.57 m ² 6,522.17 m ²	574 ft² 44 ft² 67 ft² 69,519 ft² 70,204 ft²
Lobby	0.00 m ² 53.30 m ² 4.05 m ² 6.25 m ² 6,458.57 m ² 6,522.17 m ² 12.48 m ²	574 ft² 44 ft² 67 ft² 69,519 ft² 70,204 ft² 134 ft²
Lobby se	0.00 m ² 53.30 m ² 4.05 m ² 6.25 m ² 6,458.57 m ² 6,522.17 m ² 12.48 m ² 27.07 m ²	574 ft² 44 ft² 67 ft² 69,519 ft² 70,204 ft² 134 ft² 291 ft²
Lobby	0.00 m ² 53.30 m ² 4.05 m ² 6.25 m ² 6,458.57 m ² 6,522.17 m ² 12.48 m ²	574 ft² 44 ft² 67 ft² 69,519 ft² 70,204 ft² 134 ft² 291 ft² 45 ft²
Lobby	0.00 m ² 53.30 m ² 4.05 m ² 6.25 m ² 6,458.57 m ² 6,522.17 m ² 12.48 m ² 27.07 m ² 4.21 m ²	574 ft² 44 ft² 67 ft² 69,519 ft² 70,204 ft² 134 ft² 291 ft²
Lobby	0.00 m ² 53.30 m ² 4.05 m ² 6.25 m ² 6,458.57 m ² 6,522.17 m ² 12.48 m ² 27.07 m ² 4.21 m ² 609.71 m ²	574 ft² 44 ft² 69,519 ft² 70,204 ft² 134 ft² 291 ft² 45 ft² 6,563 ft²
Lobby	0.00 m ² 53.30 m ² 4.05 m ² 6.25 m ² 6,458.57 m ² 6,522.17 m ² 12.48 m ² 27.07 m ² 4.21 m ² 609.71 m ² 2.04 m ²	574 ft^2 44 ft^2 $69,519 \text{ ft}^2$ $69,519 \text{ ft}^2$ $70,204 \text{ ft}^2$ 134 ft^2 291 ft^2 45 ft^2 $6,563 \text{ ft}^2$ 22 ft^2

Draw	<i>i</i> ing Status		
	CONSTRUCTION		
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speci	drawing shall be read in conjunction with all other relevant drawin fications and associated documentation. Any discrepencies, erro sions are to be reported to the originator before proceeding with v	rs or	
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inforn file fo	rojects does not accept liability for any loss or degradation of any nation held in the drawing resulting from the translation from the rmat to any other file format or from the recipients reading of it in programme.	original	
<u>^</u>	Hazard Identification		
ref	hazard	date	

PROJECT NOTES 1. Design information indicated on this drawing is to be used

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- Soft Landscaping shown is indicative, refer to Landscape Architect design for full details. 3.
- 4. Any proposed levels are indicative and subject to change to suit engineered solutions.

Gross Internal Area (GIA) Requirements

Development proposals comprise of the following GIA accommodation. Check measurements will be recorded as listed below and as depicted on the floor plans.

Warehouse Area: Dimensions taken to inside face of the sheeting rails.

Office: Dimensions taken to internal finished faces of perimeter wall linings.

2. For contractual requirements on building areas and schedule of minimum GIA'S refer to the "Employers requirements" document.

3. GIA dimensions on this drawing are target value only. **Employers requirements** to achieve minimum GIA accommodation shall **take precedence**.

The contractor's designers are to provide 'measurement Plans' for employer approval. These shall confirm how GIA requirements will be achieved.

5. ALL dimensions indicated are subject to change during detailed design of structural steel frame and building envelope systems. Full coordination required with all relevant sub- contractors / specialists.

C01	Full Construction Issue	SS	08.09.22	
P11	Co-ord update and Construction Issue		02.08.22	SS
P10	Fabrication Model co-ordination update	SS	26.07.22	
P9	General Update.Contract Issue.	A.AL	29.06.22	SS
P8	PLANNING ISSUE. Notes amended as required by Planning.	A.AL	01.06.22	SS
P7	Office extended to GL6	SS	24.05.22	
P6	Layout & Areas updated	A.AL	19.05.22	SS
P5	SE Co-ordination and specifications Updated.	A.AL	27.04.22	SS
P4	Layout Updated	A.AL	21.04.22	SS
P3	Tender issue	AR	24.01.22	BE
P2	Scale Note Amended	BC	13.12.21	DC
P1	First Issue of Drawing	BE	16.11.21	DC
Rev	Revision Details	Drawn	Date	Checked

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Client


GP Developments (Newbury) Limited


Project New Industrial Units Newbury

Drawing Title

Unit 2-Building GA Plan(Level00)

Drg no. 21012-C4F	P-V2-ZZ-D	R-A-200	1	Rev C01
C4 Job no.	21012	Scale A	s indicated	@ A1
Drawn by	BE	Created	08	.11.21

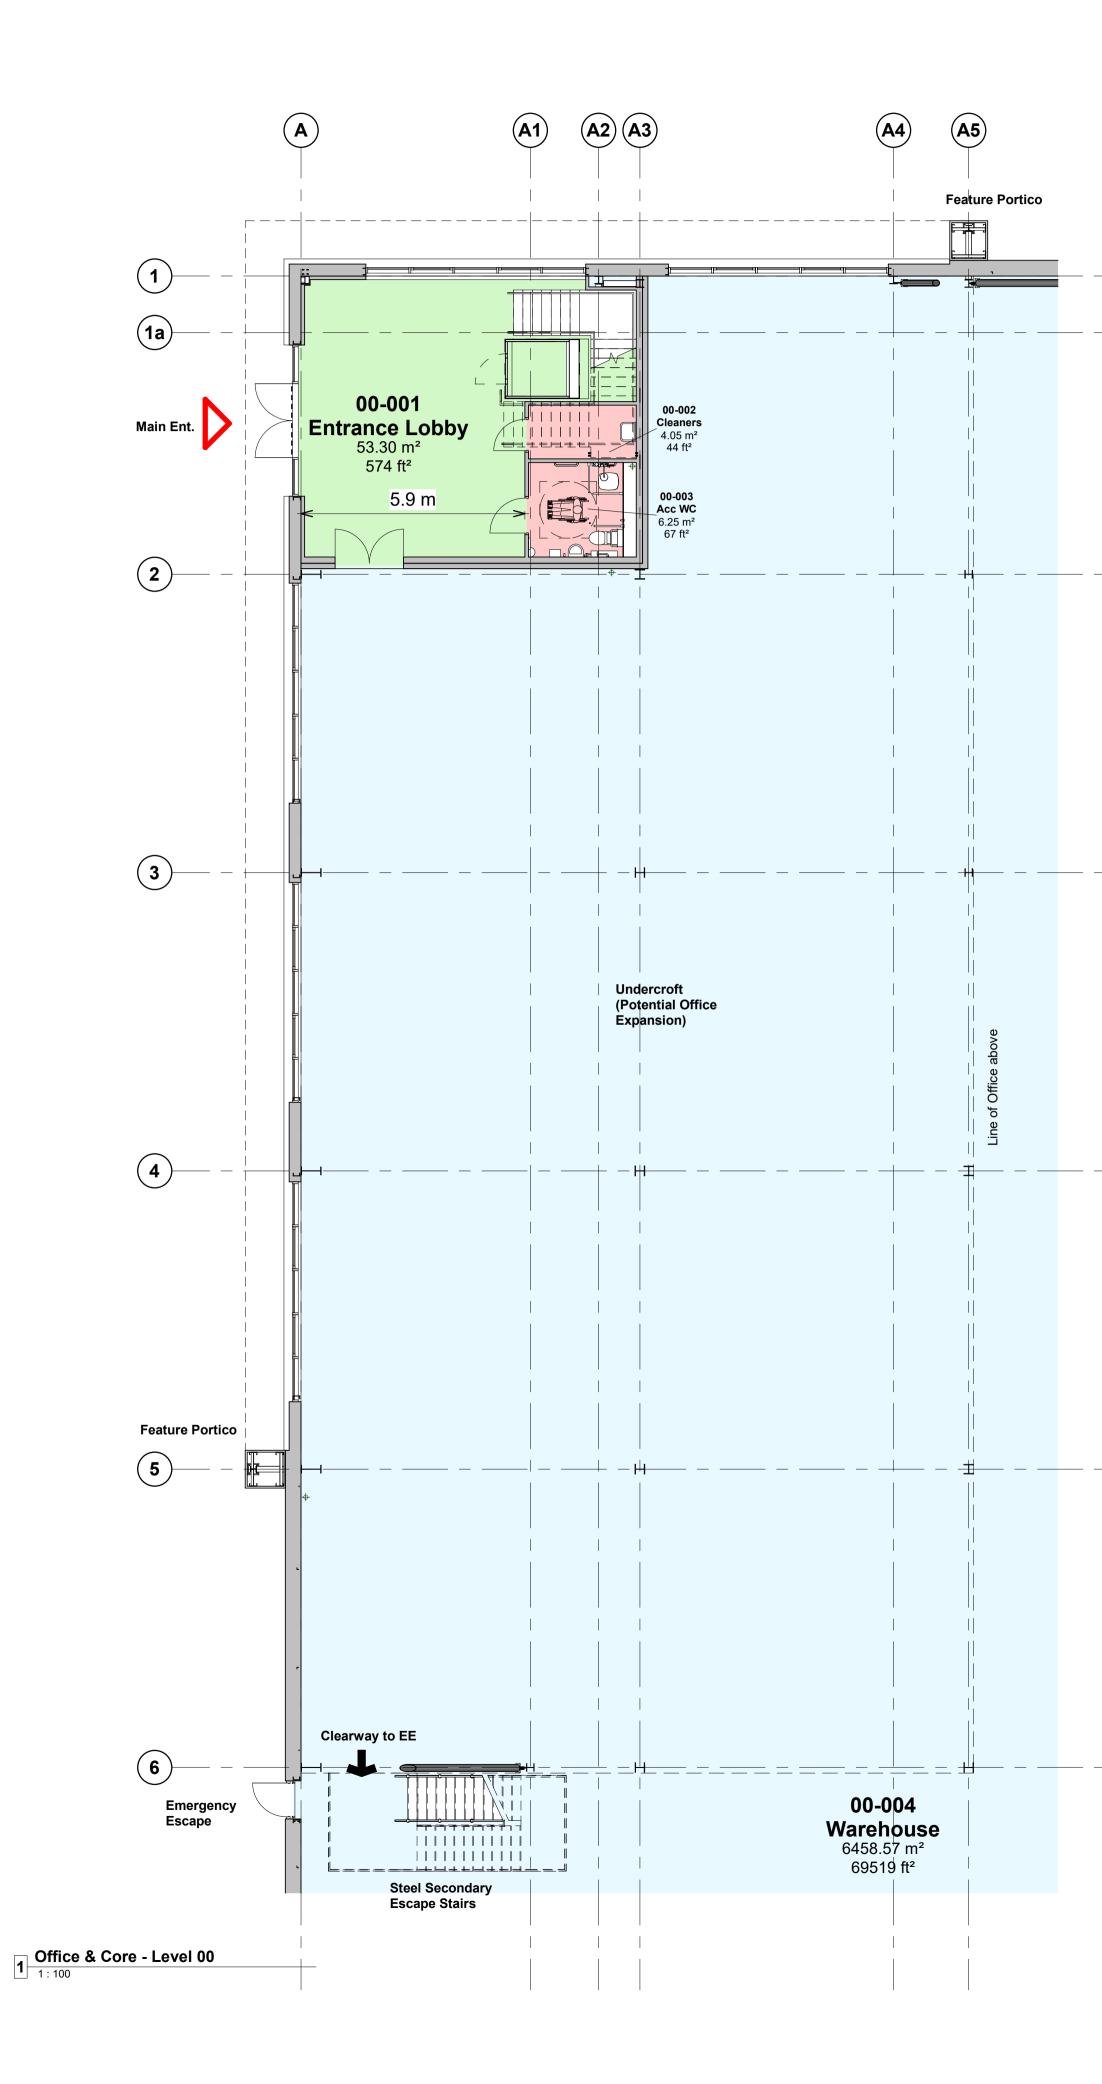

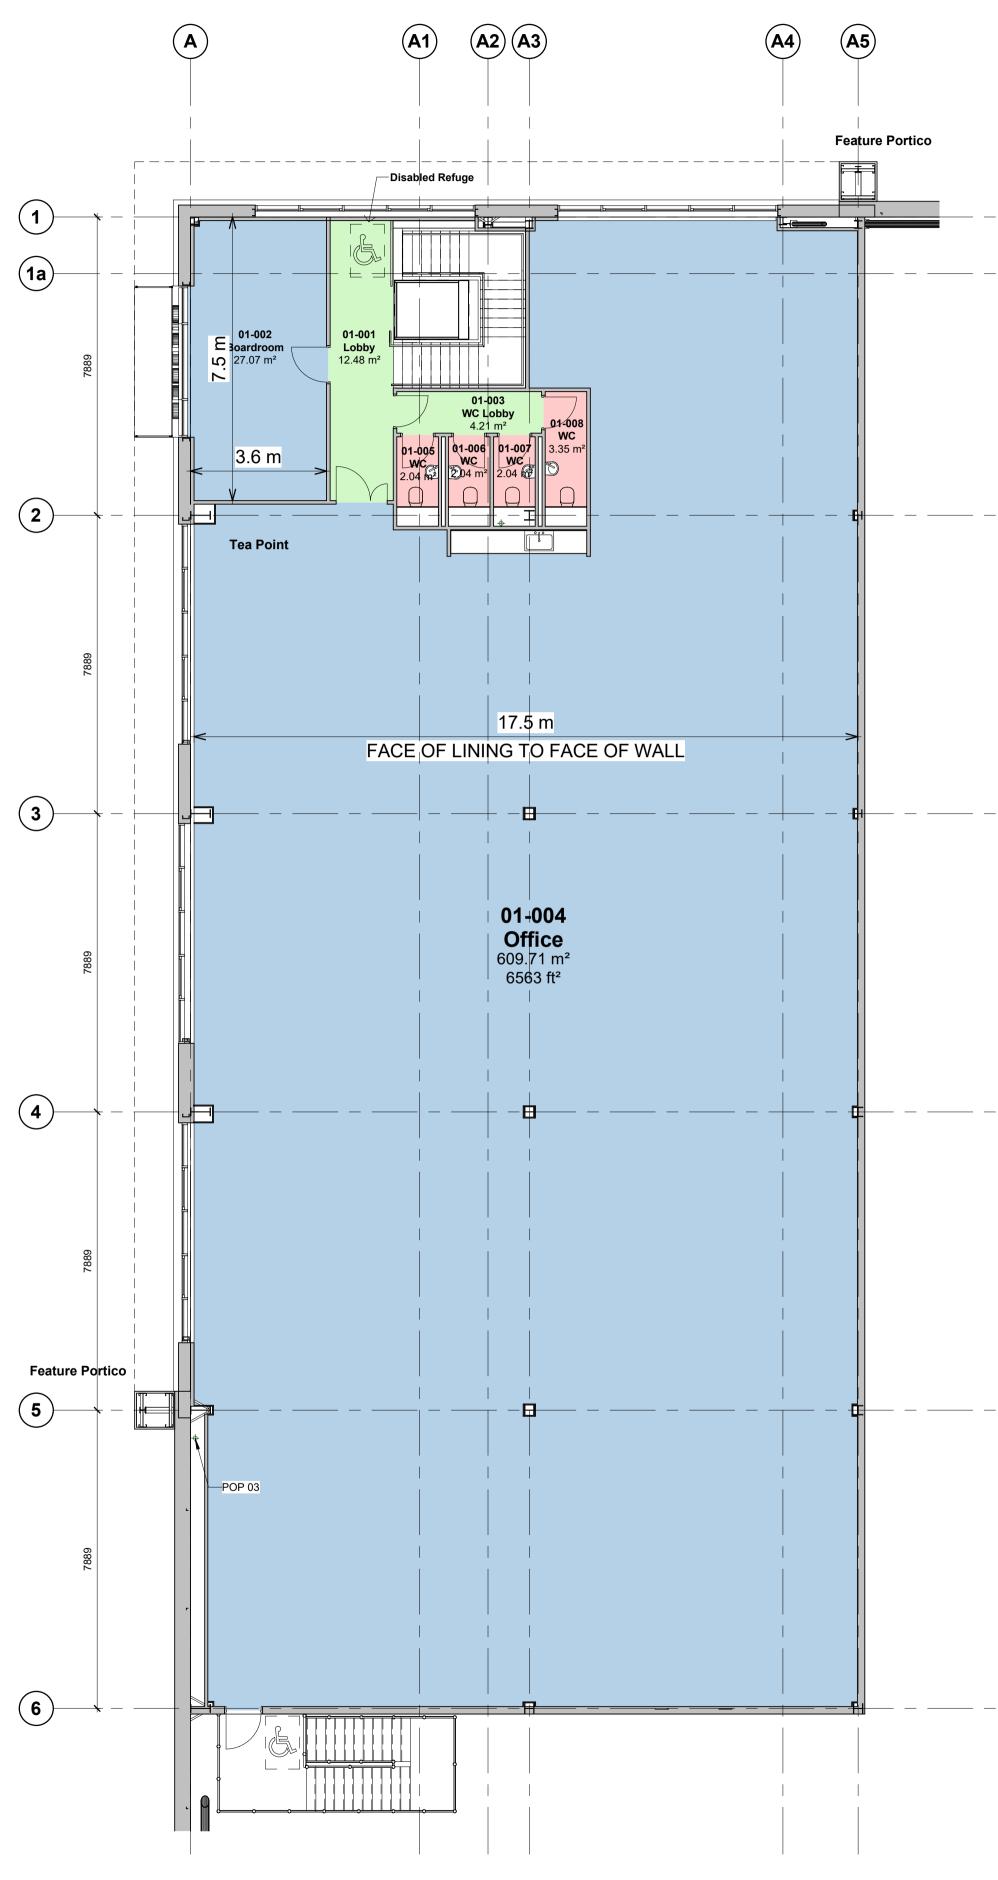



N	0m 2m VISUAL SCALE	4m 1.100 @ A	6m 1	8m	Drawing Status CONSTRUCTION
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ref hazard

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date

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- Any proposed levels are indicative and subject to change to suit engineered solutions.

C01	Full Construction Issue	SS	08.09.22	
P7	Co-ord update and Construction Issue		02.08.22	SS
P6	General Update.Contract Issue.	A.AL	29.06.22	SS
Р5	PLANNING ISSUE. Notes amended as required by Planning.	A.AL	01.06.22	SS
P4	Pop ups indicated.	A.AL	25.05.22	SS
P3	Office extended to GL6	SS	24.05.22	
P2	Layout & Areas updated	A.AL	19.05.22	SS
P1	First Issue of Drawing	A.AL	03.05.22	SS
Rev	Revision Details	Drawn	Date	Checked



Client


GP Developments (Newbury) Limited

Project New Industrial Units Newbury

Drawing Title

Unit 2 - Office&Core GA Plans

Drawn by	A.AL	Created	03.05.22	
C4 Job no.	21012	Scale	1 : 100	@ A1
Drg no. 21012-C4I	P-V2-ZZ-D	R-A-2002	2	Rev C01

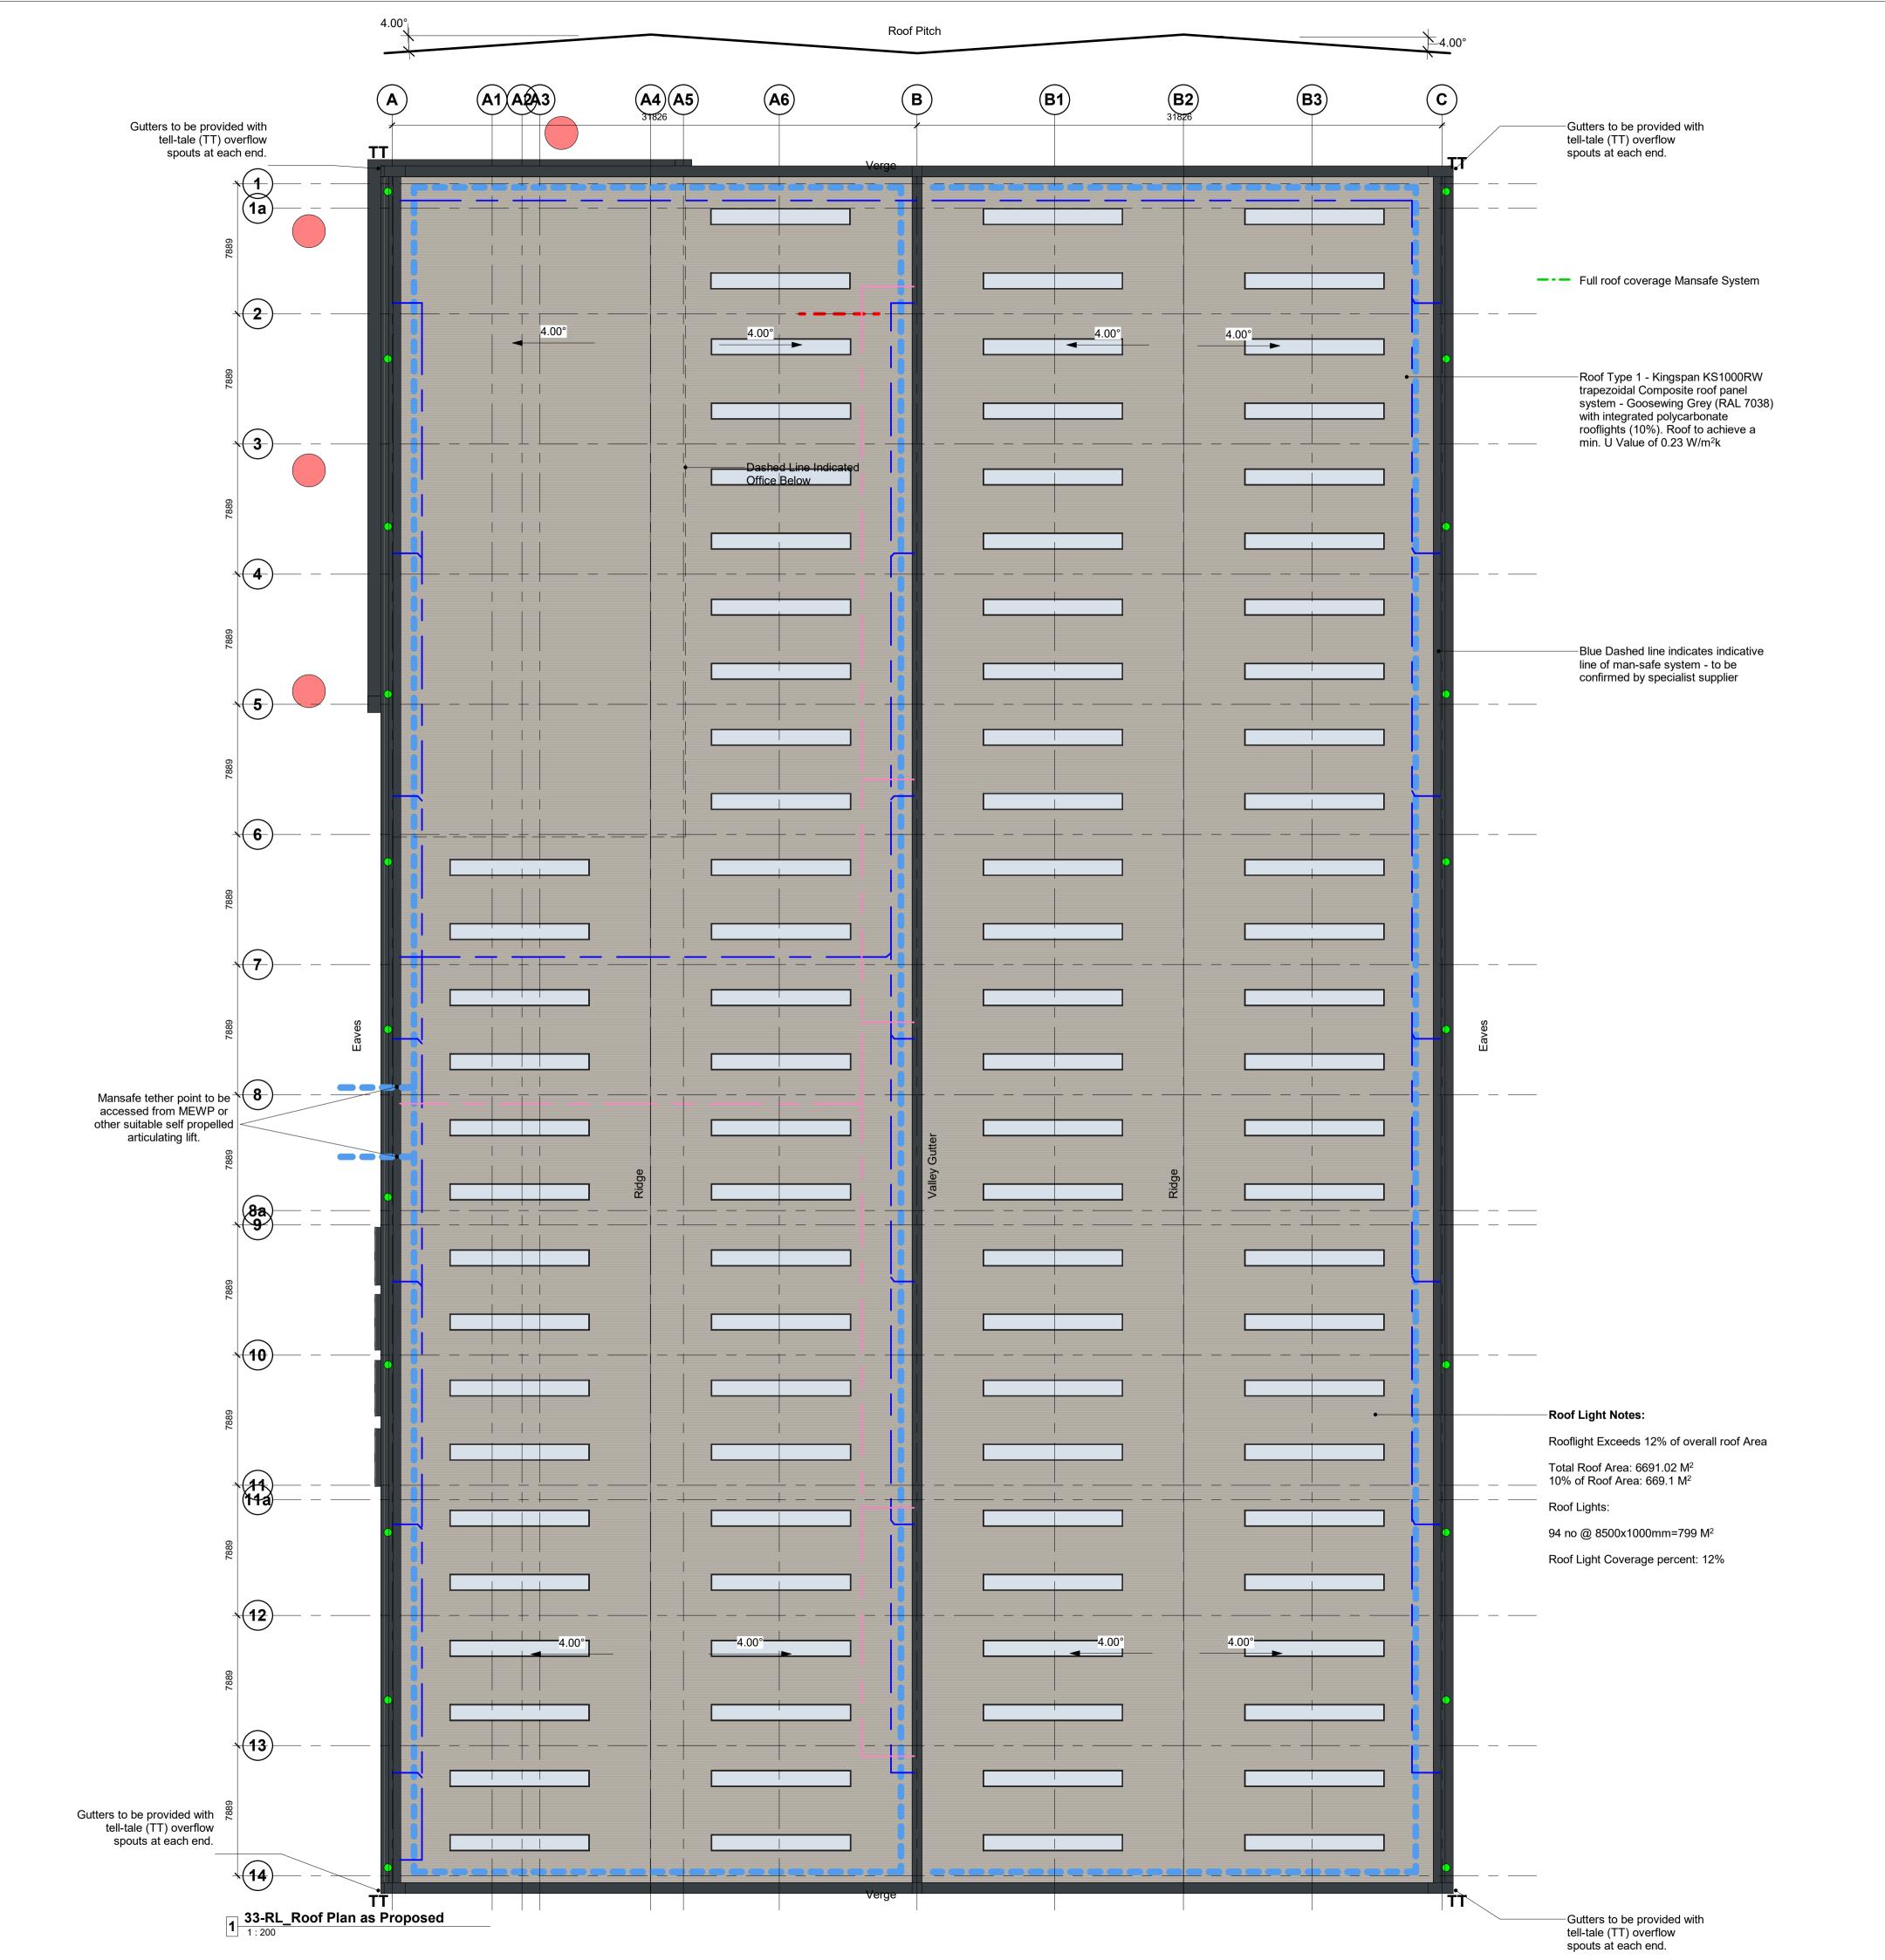

N

0m	4m	8m	12m	16m		
VISUAL SCALE 1:200 @ A1						

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Roof Plan Key



Blue dashed line indicates indicative line of man safe system-to be confirmed by specialist supplier

Gutter and valley to be provided with tell-tale (Indicated as TT) overflow spouts at each end.

Centerline indicates syphonic drainage system to be confirmed - refer to design by Engineer.

Key to Access and Maintenance

External Glazing Maintenance-Telescopic pole from

Ground Level, Maximum vertical reach 13m



Rainwater Goods Cleaning-To be carried out via Roof Mansafe Latchway system. Fall Protection system designed and fitted to comply with BS EN 795:2012

U-VALUES, AIR PERMEABILITY & TESTING

U-VALUES Please refer to BRUKL calculations for further information

Calculate area-weighted average U-values External Walls 0.26 W/m²K Party Walls 0.26 W/m²K Ground Floor 0.22 W/m²K Roof 0.23 W/m²K External Personnel Doors 2.2 W/m²K Windows 1.6 W/m²K Curtain Wall 1.6 W/m²K Roller Shutters 1.5 W/m²K

AIR PERMEABILITY AND PRESSURE TESTING

Reasonable provision shall be made to ensure the building is constructed to minimise unwanted air leakage through the new building fabric. The measured air permeability to be in compliance with the Target CO2 Emission Rate (TER) design limits.

Air Permeability 5 m³/(hxm²) at 50 Pa All buildings above 500 m² of total useful floor area must be subject to pressure testing

ADDITIONAL NOTES:

Only **non-combustible** materials are to be used on the building envelope

	Hazard Identification	
ref	hazard	date

ked



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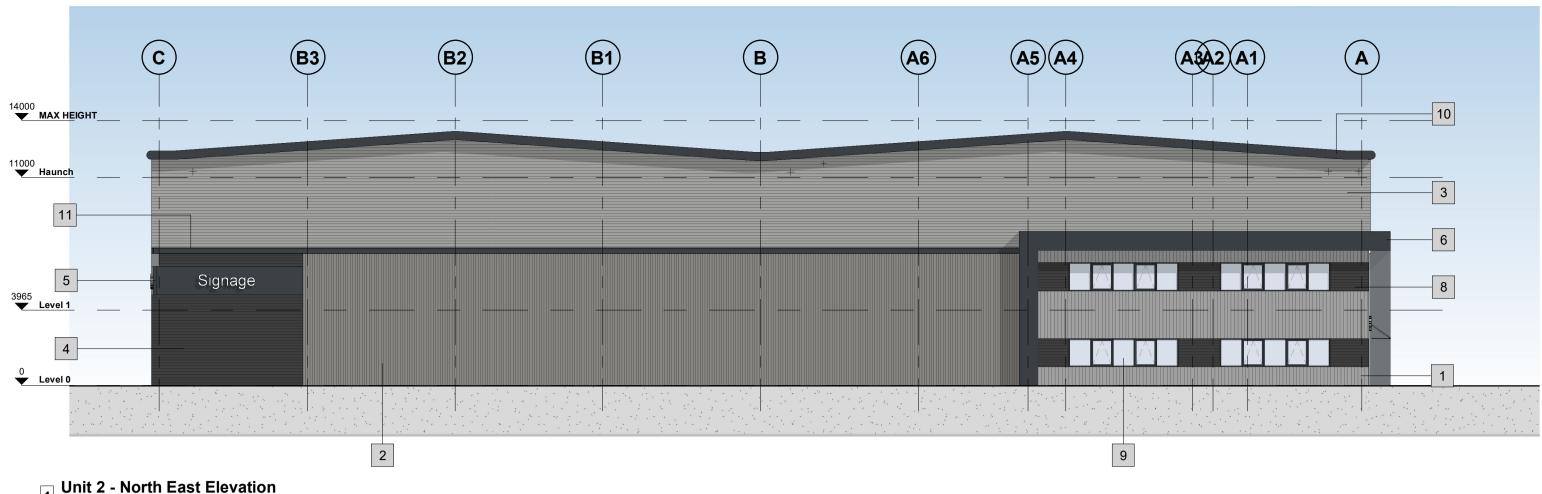
GP Developments (Newbury) Limited

Project New Industrial Units Newbury


Drawing Title Unit 2 - Roof Plan as Proposed

Status Purpose of Issue B PARTIALLY SIGNED-OFF


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C4 Job no.	21012	Scale	As indicated	@ A1
Drg no. 21012-C4F	P-V2-RL-D	R-A-3	301	Rev C01




Unit 2 - North East Elevation

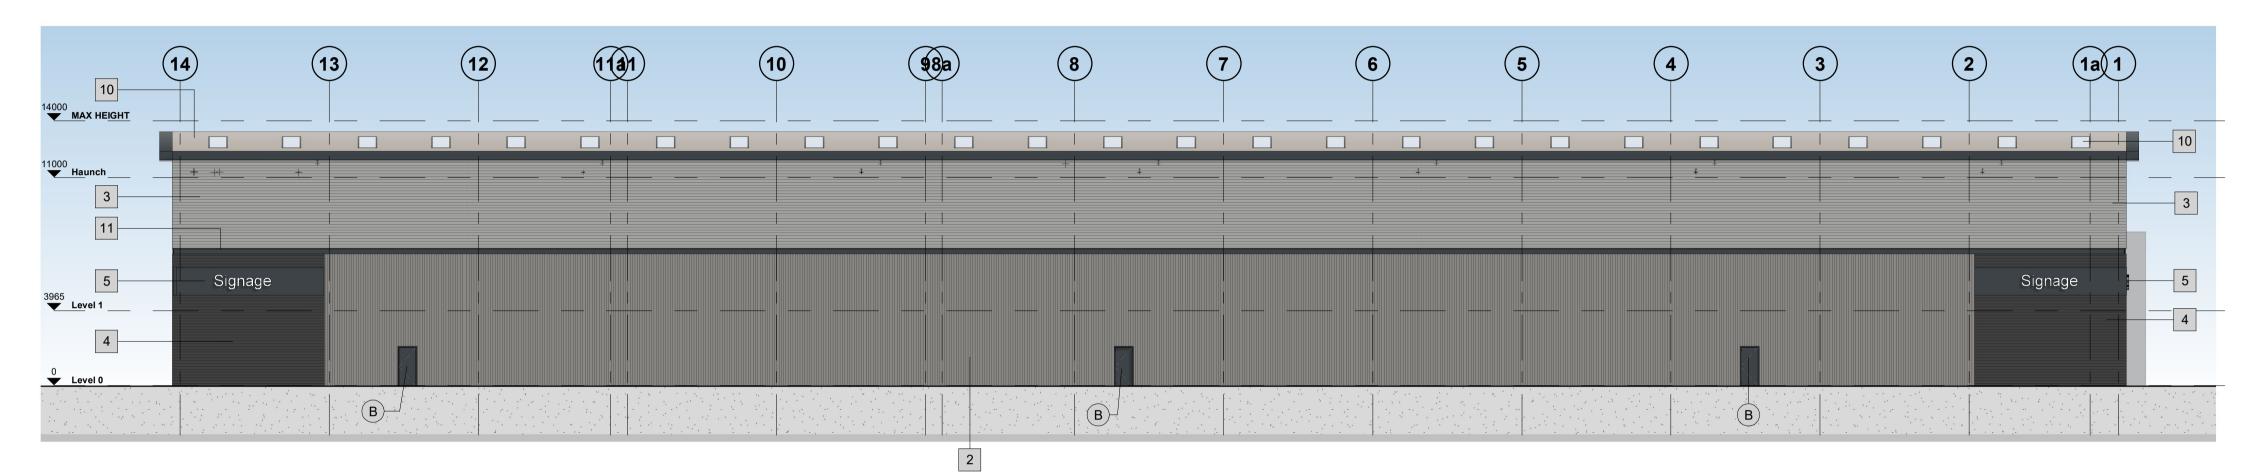

2 Unit 2 - South East Elevation

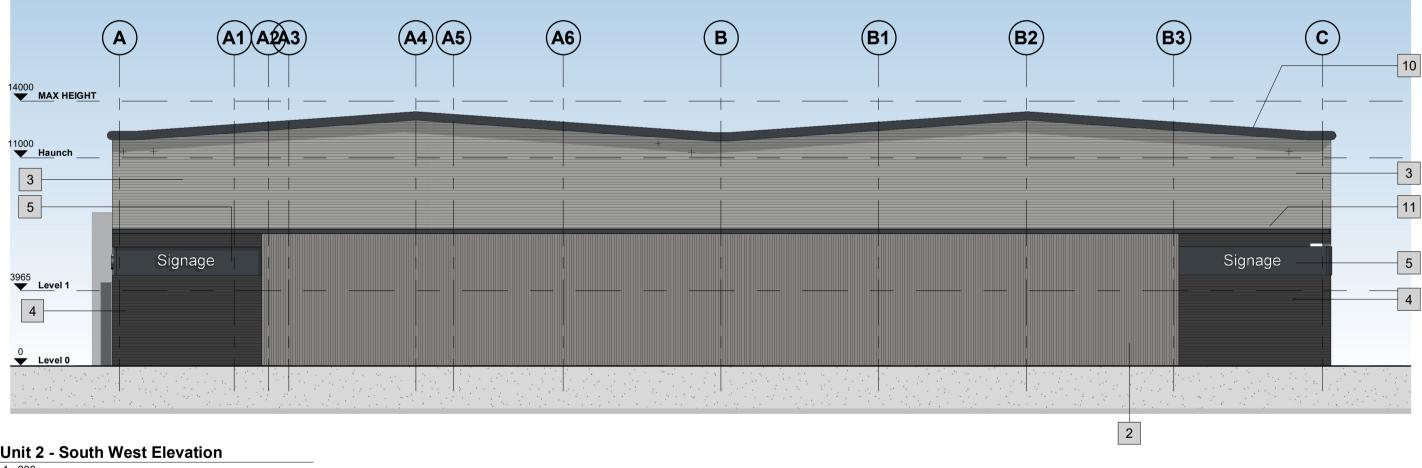

3 Unit 2 - South West Elevation

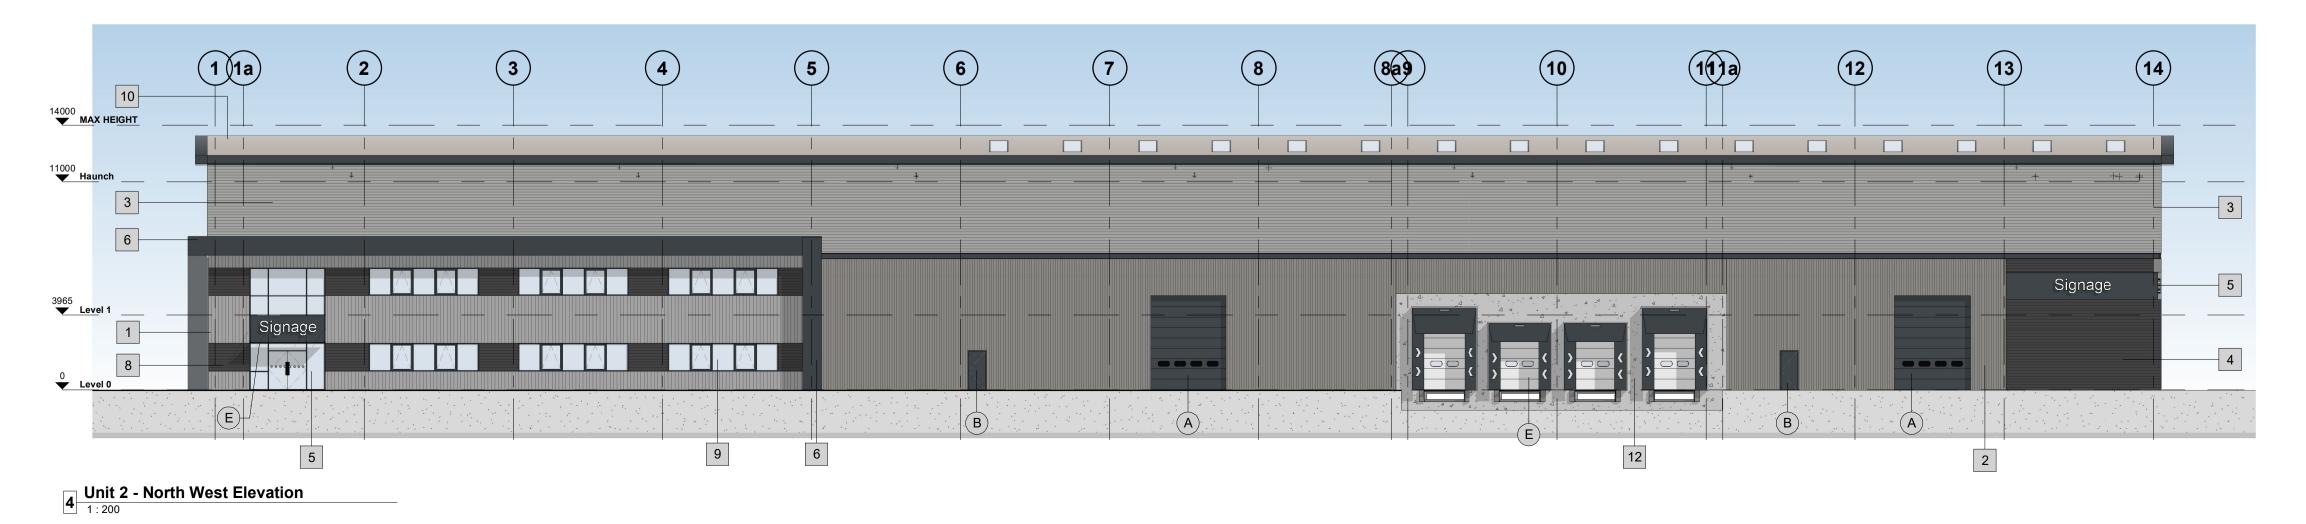

Building Fabric Materials Schedule


11

12

DUI	iding Fabric Materials Schedule		
1	Wall Type 1 - Vertical plank pattern (180mm wide) secret-fixed steel cladding panels ppc in White Aluminium (RAL 9006) on insulated composite cladding carrier panel.		Operati
2	Wall Type 2 - Built-up metal Cladding (twin skinned, insulated) Vertical Trapezoidal profile - Grey Aluminium (RAL 9007)	A	plastisc
3	Wall Type 3 - Built-up metal Cladding (twin skinned, insulated) Horizontal Trapezoidal profile -White Aluminum (RAL 9006)	В	Person steel, th
4	Wall Type 4 - Built-up metal Cladding (twin skinned, insulated) Horizontal Trapezoidal profile -Anthracite (RAL 7016)	С	Alumini (RAL 7
5	Wall Type 5 - Pressed Aluminium Sheeting Flat Profile (twin skinned, insulated), PPC finish Anthracite (RAL 7016) Signage by occupier	D	Glazed
6	Wall Type 6 - Microrib finish cladding panels to feature surround portico fascia and column fronts and sides, with flat plank-pattern panels to portico soffit. All elements to have PPC finish in Anthracite (RAL 7016)	E	Double Silver/G
7	Wall Type 7 - Aluminium Curtain Wall stick frame system PPC Anthracite (RAL 7016) framing, double glazed infills (solar control)		
8	Integrated feature louvre profile cladding panels in Anthracite (RAL 7016) between glazed elements of ribbon windows		Note: Internal
9	Double glazed aluminium ribbon window system PPC Anthracite (RAL 7016)		Maximu Portal F
10	Roof Type 1 - Composite roof panel system - Goosewing Grey (RAL 7038) with integrated polycarbonate rooflights (10%)		

Feature recessed flashing detail in Anthracite (RAL 7016)

Insulated concrete Prowall system for dock levellers and sectional doors

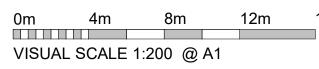

ational Door - Level Access Sectional insulated shutter. isol coated finish, Anthracite (RAL 7016)

onnel Access / Escape doorset - Warehouse Galvanised , thermally insulated core, PPC Anthracite (RAL 7016)

inium Profiled Bullnosed Eaves Gutter PPC finish Anthracite _ 7016)

ed Canopy above entrance by specialist contractor

le and single dock levellers with insulated sectional doors in r/Grey Aluminium with dock shelters in Anthracite/Black

nal Siphonic Drainage System to be installed.

mum roof height to be no more than 14m.

I Frame to be pre-set in fabrication to 4degrees.

wing Status CONSTRUCTION

16m N

12m

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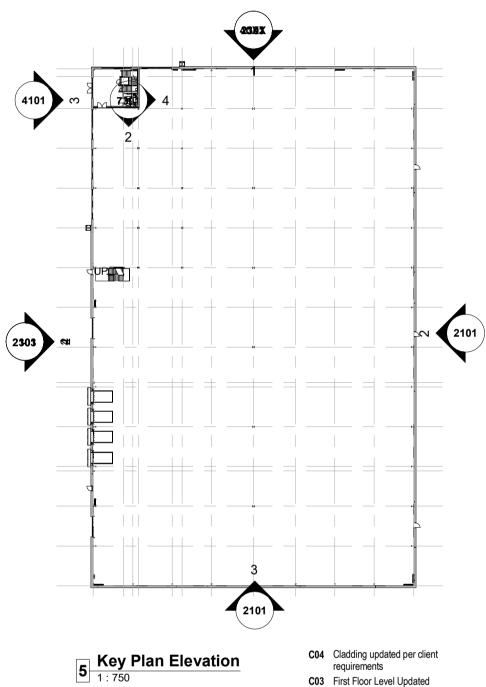
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C04	Cladding updated per client requirements	SS	26.01.23	
C03	First Floor Level Updated	GN	18.11.22	SS
C02	EDR-00-03 FE door position relocated	AR	26.09.22	SS
C01	Full Construction Issue	SS	08.09.22	
P8	Co-ord update and Construction Issue		02.08.22	SS
P7	General Update.Contract Issue.	A.AL	29.06.22	SS
P6	PLANNING ISSUE. Notes amended as required by Planning.	A.AL	01.06.22	SS
P5	SE Co-ordination and specifications Updated.	A.AL	27.04.22	SS
P4	Elevations Updated.	A.AL	21.04.22	SS
P3	Tender issue	AR	24.01.22	BE
P2	Scale Note Amended	BC	13.12.21	DC
P1	First Issue of Drawing	BE	16.11.21	DC
Rev	Revision Details	Drawn	Date	Checked

Brunel House 340 Firecrest Court

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Projects e: info@c4projects.co.uk

Project Management • Architecture • Building Surveying • Cost Consultance

Rev Revision Details

Client

U-VALUES, AIR PERMEABILITY & TESTING

U-VALUES Please refer to BRUKL calculations for further information

Calculate area-weighted average U-values External Walls 0.26 W/m²K Party Walls 0.26 W/m²K Ground Floor 0.22 W/m²K

Roof 0.23 W/m²K External Personnel Doors 2.2 W/m²K Windows 1.6 W/m²K Curtain Wall 1.6 W/m²K Roller Shutters 1.5 W/m²K

AIR PERMEABILITY AND PRESSURE TESTING Reasonable provision shall be made to ensure the building is constructed to minimise unwanted air leakage through the new building fabric. The measured air permeability to be in compliance

with the Target CO2 Emission Rate (TER) design limits. Air Permeability 5 m³/(hxm²) at 50 Pa

All buildings above 500 m² of total useful floor area must be subject to pressure testing

ADDITIONAL NOTES:

Only non-combustible materials are to be used on the building envelope

GP Developments (Newbury) Limited

Project New Industrial Units Newbury

Drawing Title

Unit 2 - Elevations as Proposed


Status Purpose S0 WORK	of Issue	RESS	
Drawn by	BB	Created	08.11.21
C4 Job no.	21012	Scale As indicate	d @ A1
Drg no. 21012-C4P-V2-ZZ-DR-A-2101		Rev C04	

Building Fabric Materials Schedule


- 1 Wall Type 1 Built-up/composite metal Cladding (twin skinned, insulated) TBC Western Red Cedar Finish
- Wall Type 2 Built-up metal Cladding (twin skinned, insulated) Vertical Trapezoidal profile Grey Aluminium (RAL 9007) 2
- 3 Wall Type 3 - Built-up metal Cladding (twin skinned, insulated) Horizontal Trapezoidal profile -White Aluminum (RAL 9006)
- 4 Wall Type 4 Aluminium Curtain Wall stick frame system PPC Anthracite (RAL 7016) framing, double glazed infills (solar control)
- 5 Wall Type 5 Pressed Aluminium Sneeding Flact rolling (PPC finish Anthracite (RAL 7016) Signage by occupier. Wall Type 5 - Pressed Aluminium Sheeting Flat Profile (twin skinned, insulated),
- Wall Type 6 Pressed Aluminium Sheeting to Feature Surround 6 Wall Type 6 - Pressed Aluminium Sheeting to Feature St Flat faced panels (uninsulated), open joints, PPC finish Anthracite (RAL 7016)
- Anthracite (RAL 7016) Feature recessed detail flashing
- 7 Feature recessed detail Anthracite (RAL 7016)
- 8 Integrated timber effect louvre system - to match timber colour cladding
- 9 Double glazed aluminium ribbon window system PPC Anthracite (RAL 7016)
- Roof Type 1 Composite roof panel system Goosewing Grey 10Roof Type 1 - Composite roof panel system - Goosewing Gi10(RAL 7038) with integrated polycarbonate rooflights (10%)

- Operational Door Level Access A Sectional insulated shutter, plastisol coated finish, Anthracite (RAL 7016)
- Personnel Access / Escape doorset Warehouse В Galvanised steel, thermally insulated core, PPC Anthracite (RAL 7016)
- С Double & Single Dock Leveller & inflatable shelter. In Concrete Prowall System.
- D Aluminium Profiled Bullnosed Eaves Gutter PPC finish Anthracite (RAL 7016)
- E Glazed Canopy above entrance.

Note: Internal Siphonic Drainage System to be installed Portal Frame to be pre-set in fabrication to 4 degrees.

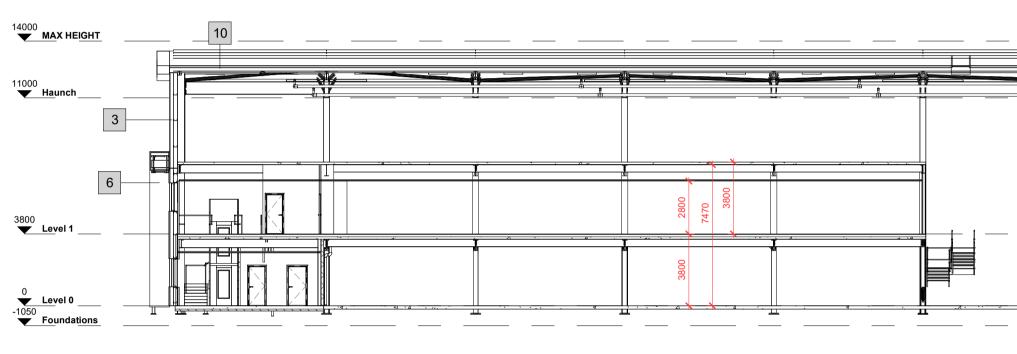

A SECTION A

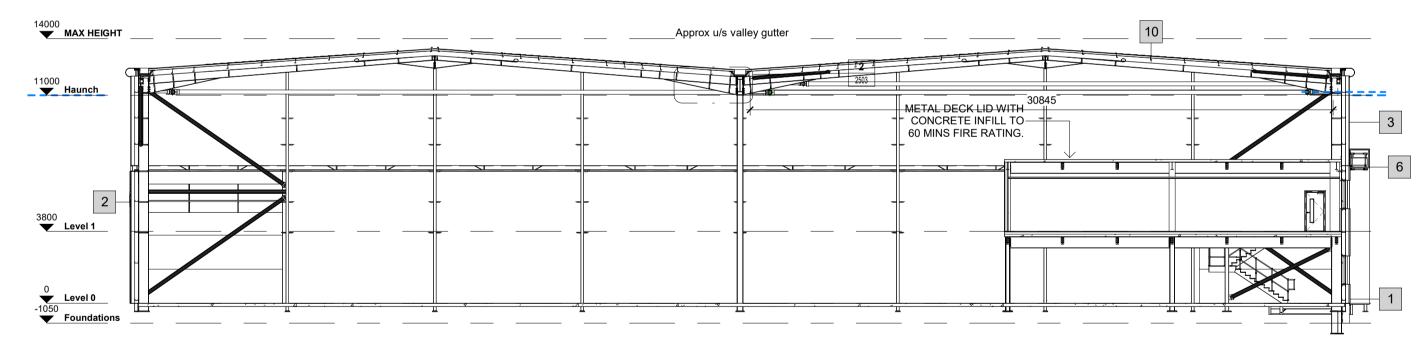

B SECTION B 1 : 200

U-VALUES, AIR PERMEABILITY & TESTING

U-VALUES Please refer to BRUKL calculations for further information

Calculate area-weighted average U-values External Walls 0.26 W/m²K Party Walls 0.26 W/m²K


Ground Floor 0.22 W/m²K Roof 0.23 W/m²K External Personnel Doors 2.2 W/m²K Windows 1.6 W/m²K Curtain Wall 1.6 W/m²K Roller Shutters 1.5 W/m²K

AIR PERMEABILITY AND PRESSURE TESTING Reasonable provision shall be made to ensure the building is constructed to minimise unwanted air leakage through the new building fabric. The measured air permeability to be in compliance with the Target CO2 Emission Rate (TER) design limits. Air Permeability 5 m³/(hxm²) at 50 Pa

All buildings above 500 m² of total useful floor area must be subject to pressure testing

ADDITIONAL NOTES:

Only **non-combustible** materials are to be used on the building envelope

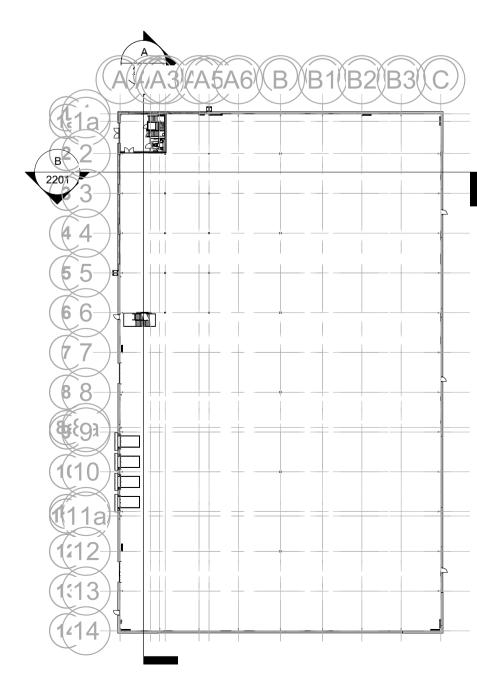

Key Plan 1 : 750

	0m	4m	8m	12m	16m
\Box	VISUA	L SCALE 1	I:200 @ A	1	

wing Status CONSTRUCTION

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REFERENCE DRAWINGS

Refer to 01/02/05/06/62 Series For Site Information

- Refer to 20 Series For Building GA Plans Refer to 21 Series For Building GA Elevations
- Refer to 22 Series For Building GA Sections Refer to 24 Series For Ceiling Plans
- Refer to 25/26 Series For Detailed Sections and Plans Refer to 30 Series for Floor Types
- Refer to 32 Series For Inetrnal Partition Types
- Refer to 40 to 45 Series For Schedules Refer to 62 Series for Fire Strategies Refer to 72/73 Series for Room Details

Rev	Revision Details	Drawn	Date	Checked
P1	Tender issue	AR	24.01.22	BE
P2	SE Co-ordination and specifications Updated.	A.AL	27.04.22	SS
P3	SE frame indicated	SS	20.05.22	
P4	Office extended to GL6	SS	24.05.22	
P5	Note added:Portal frame to be pre-set in fabrication to 4 degrees.	A.AL	27.05.22	
P6	General Update.Contract Issue.	A.AL	29.06.22	SS
P 7	Co-ord update and Construction Issue		02.08.22	SS
C01	Full Construction Issue	SS	08.09.22	

Quayside


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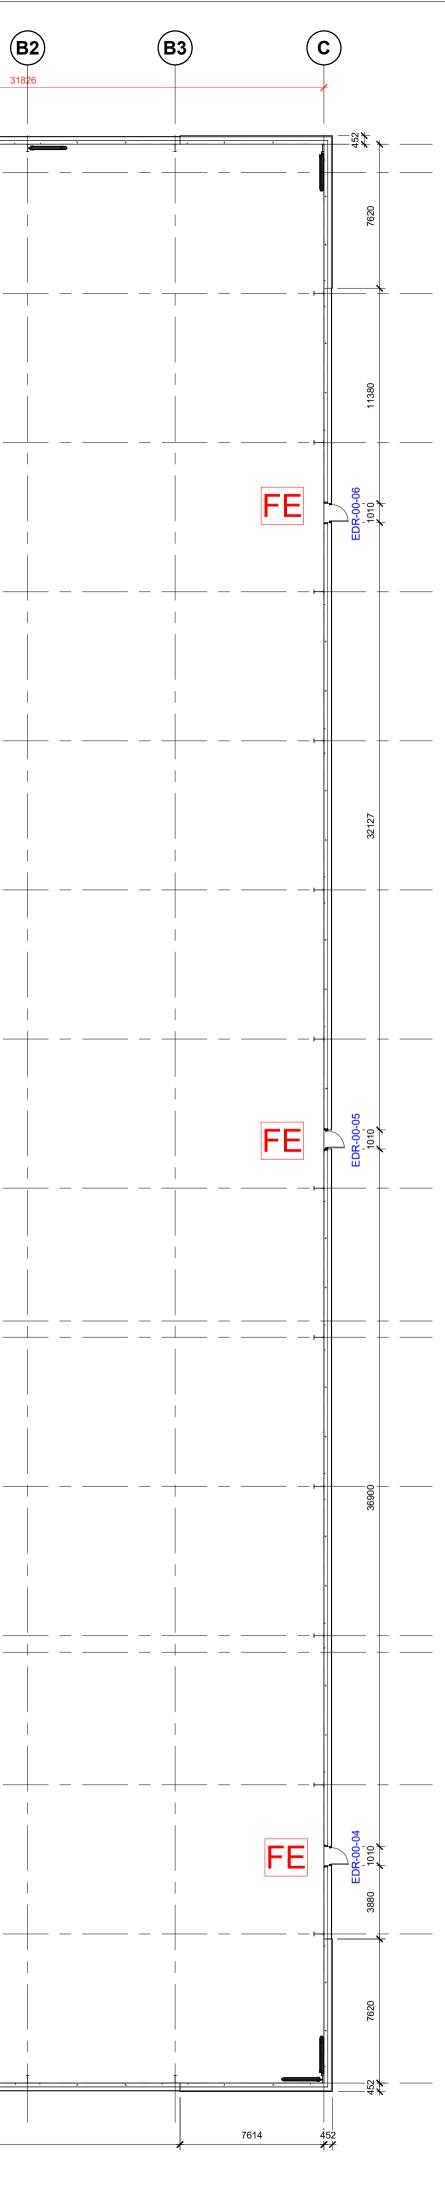
Client GP Developments (Newbury) Limited


Project New Industrial Units Newbury

Drawing Title Unit 2 - GA Sections as Proposed

Drawn by	BE	Create	d	JAN 22
C4 Job no.	21012	Scale	As indicated	@ A1
Drg no. 21012-C4F	P-V2-ZZ-D	R-A-2	201	Rev C01



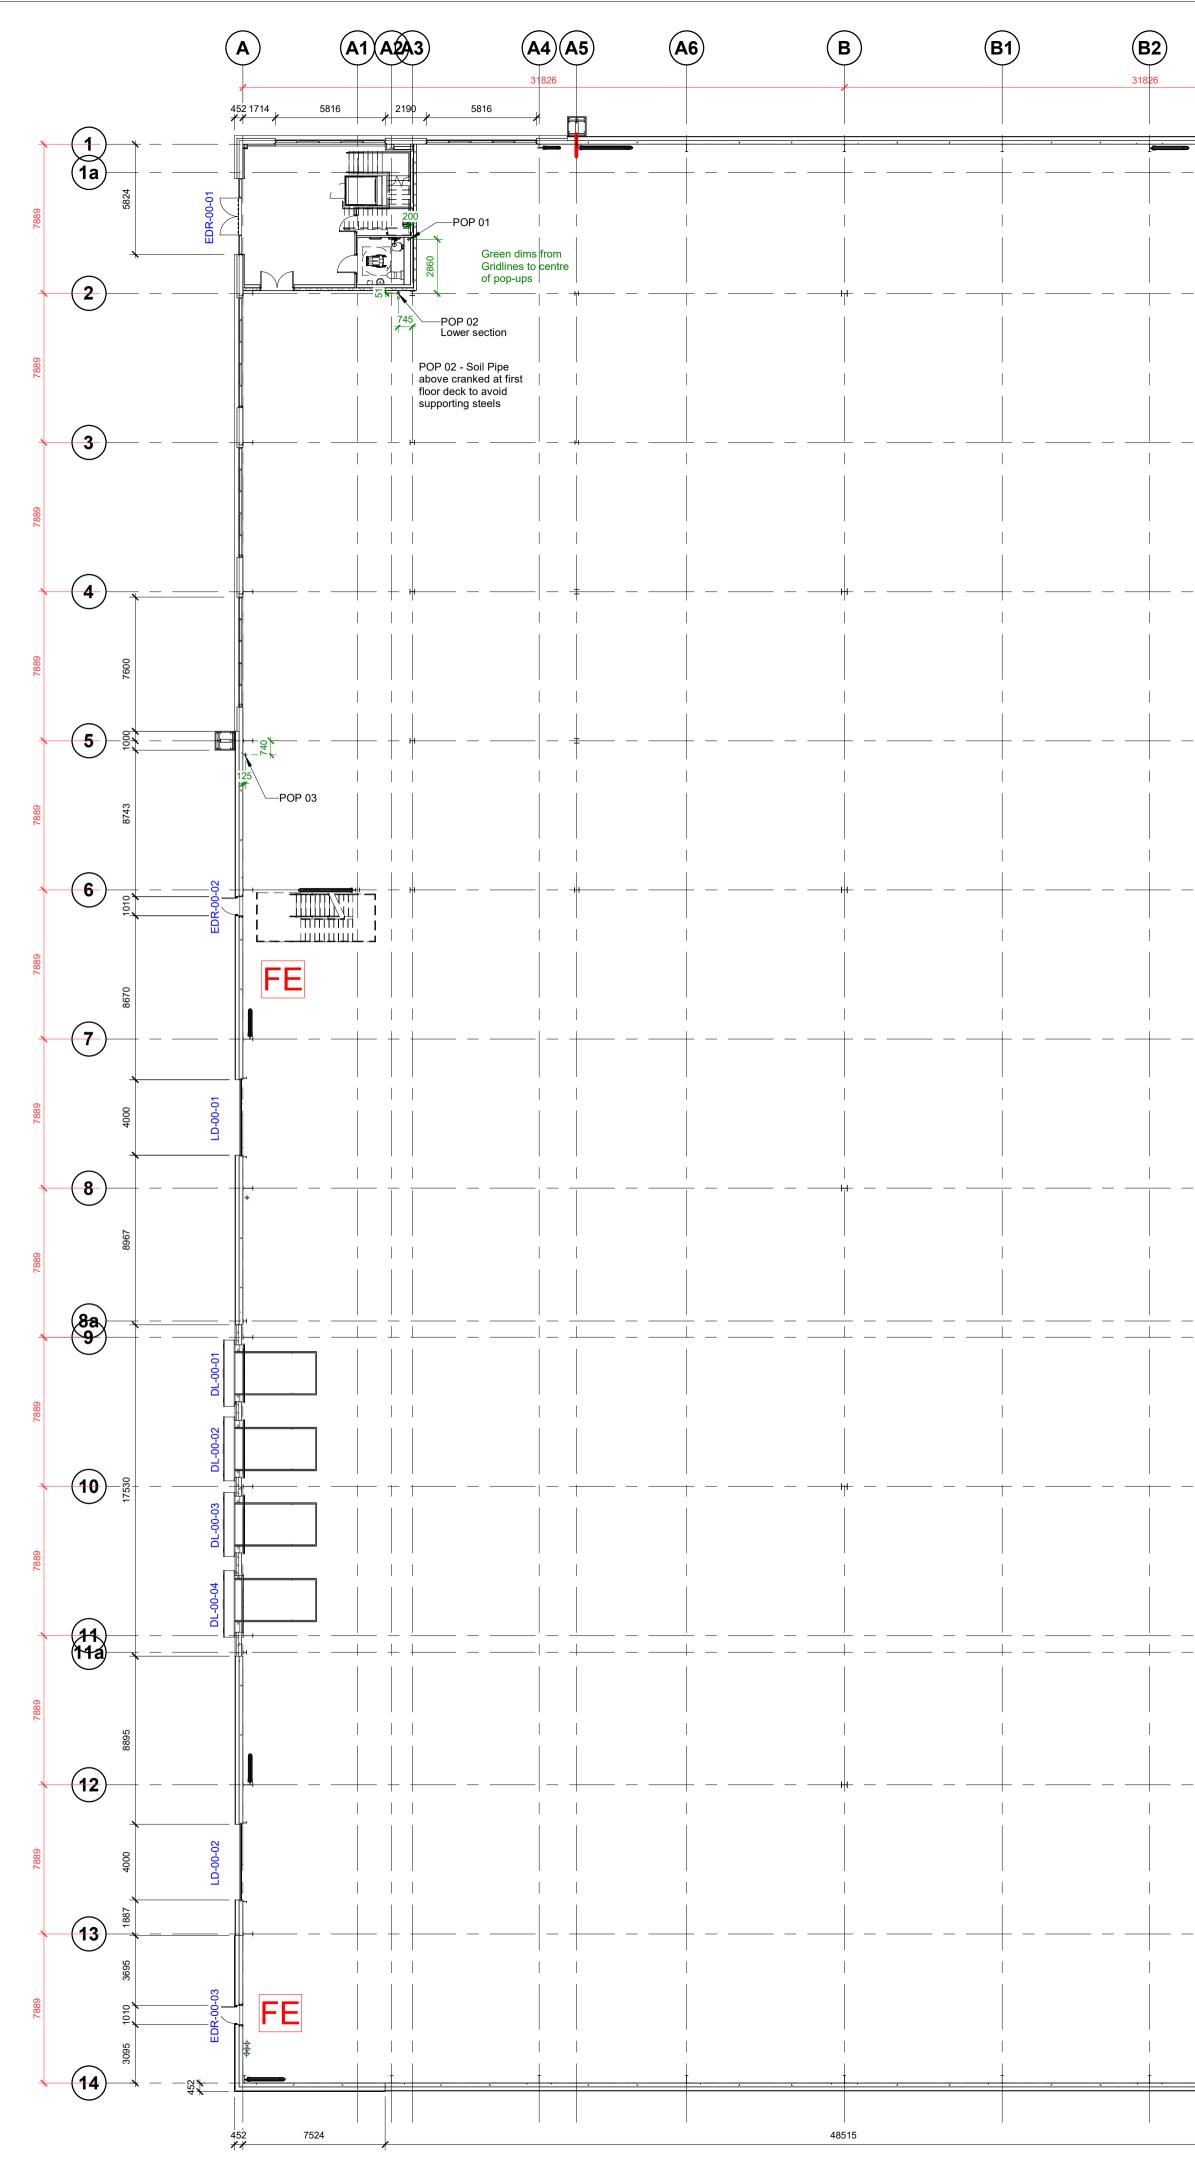

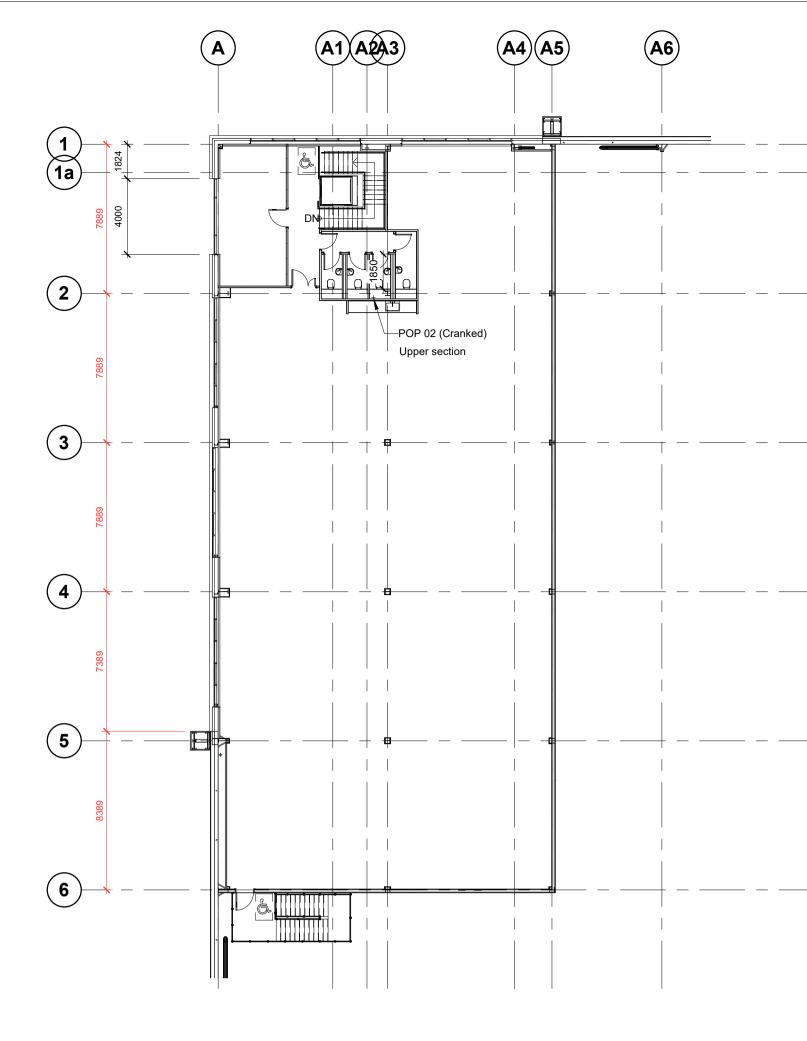

2 23-01_Setting-Out Plan - Level 01

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 _					This drawing shall be read in conjunction with all other relevant drawings, specifications and associated documentation. Any discrepencies, errors or omissions are to be reported to the originator before proceeding with work.	
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DENOTES POP UP LOCATON - TO BE CONFIRMED BY CLIENT. ALL DIMENSIONS ARE FROM GRID LINES.



REFER TO WALL DRAWINGS FOR INTERNAL WALL POSITIONS (SERIES 32)

Grid line dimension

Setting out dimension

C01	Full Construction Issue		SS	08.09.22	
•••					
P2	Construction Issue		SS	08.09.22	
P1	Tender issue		AR	24.01.22	BE
Rev	Revision Details		Drawn	Date	Checked
		1			
		0			

Project Management · Architectur

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Project Management • Architecture • Building Surveying • Cost Consultant

Client GP Developments (Newbury) Limited


Project New Industrial Units Newbury


Drawing Title Unit 2 - Setting Out Plans

 Status
 Purpose of Issue

 B
 PARTIALLY SIGNED-OFF

Drg no. 21012-C4F	P-V2-ZZ-D	R-A-2	301	Rev C01
C4 Job no.	21012	Scale	As indicated	@ A1
Drawn by	AR	Create	d	JAN 22

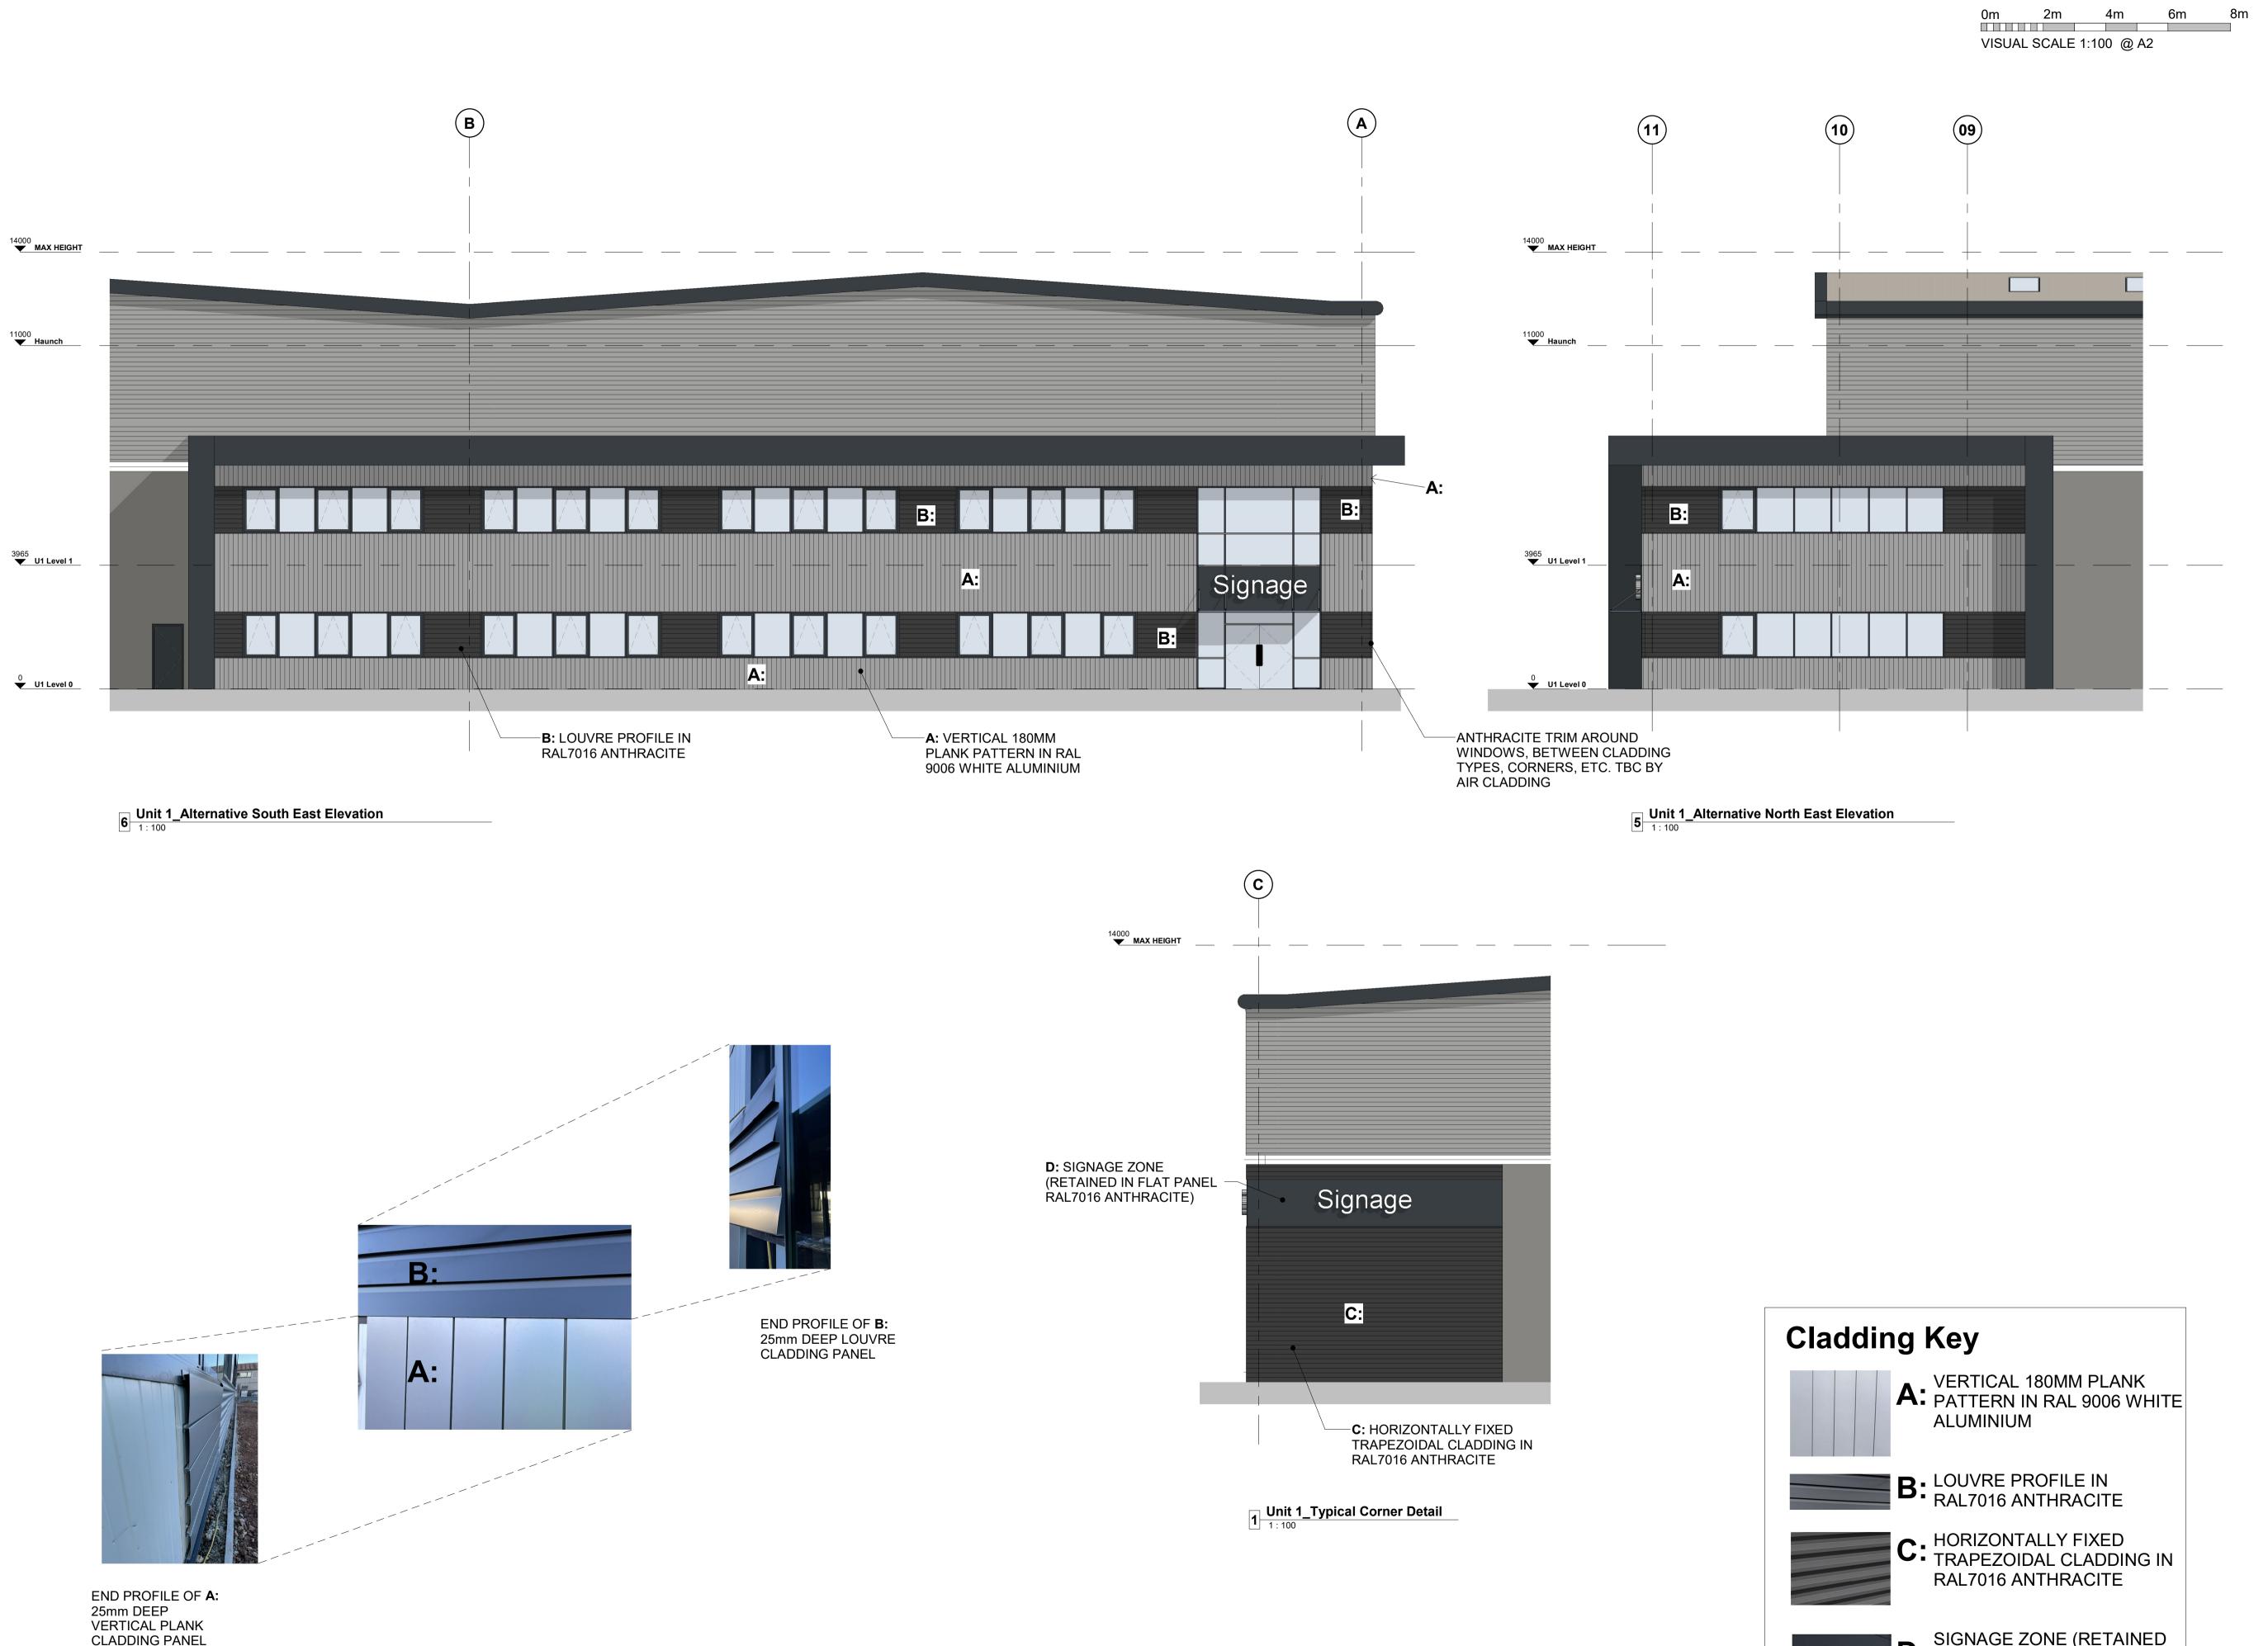

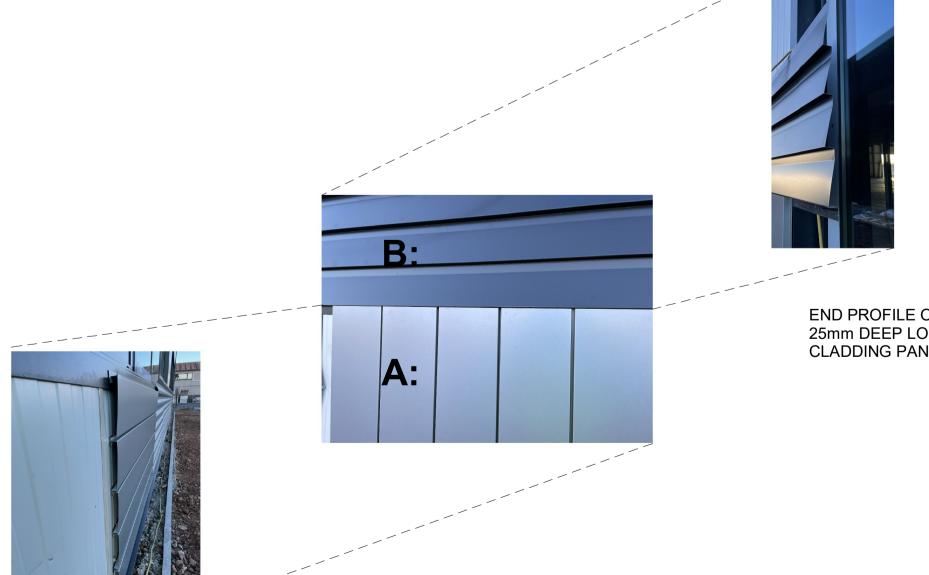

VERTICAL PLANK CLADDING PANEL

Irawing Status	
FOR COMMENT	
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DRAWING PRODUCED FOR COMMENT/APPROVAL

D: SIGNAGE ZONE (RETAINED IN FLAT PANEL RAL7016 ANTHRACITE)



Project New Industrial Units Newbury

Drawing Title Unit 1 - Alternative Elevation Treatments

Status Purpos S3 SUITA	e of Issue ABLE FOR F	REVIEW A	ND CON	IMEN
Drawn by	SS	Created	1	9.01.23
C4 Job no.	21012	Scale	1 : 100	@ A1
Drg no. 21012-C4P-V1-ZZ-DR-A-9104				Rev P1